UPGRADE EXTERIOR LIGHTING MCHENRY COUNTY COLLEGE 8900 U.S. HIGHWAY 14 CRYSTAL LAKE, ILLINOIS 60012

## 

STATE OF ILLINOIS CAPITAL DEVELOPMENT BOARD

USING AGENCY:

ILLINOIS COMMUNITY COLLEGE BOARD


KJWW ENGINEERING CONSULTANTS d/b/a KJWW PC

1100 WARRENVILLE RD.

SUITE 400W

NAPERVILLE, ILLINOIS 60563

PH: 630-527-2320

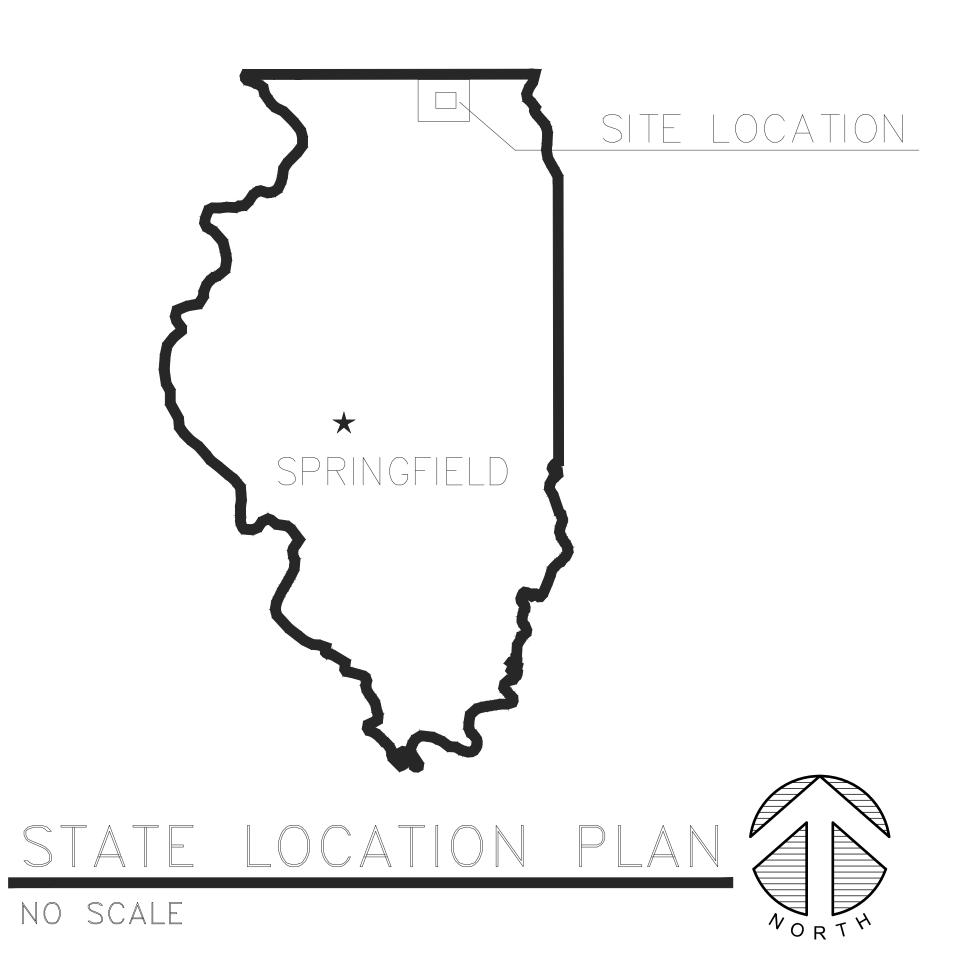





## INDEX OF DRAWINGS

REFER TO SHEET G1.01 TOTAL # OF DRAWINGS: 15

## CDB BUILDING INVENTORY NUMBERS (BIN)

BUILDING A - JC27A

BUILDING B - JC27B

BUILDING C - JC27C

BUILDING D - JC27D

BUILDING E - JC27E

BUILDING F - JC27F

PROJECT NO.

SHEET NO.

NOTE: CONTRACTOR SHALL VERIFY ALL DIMENSIONS AND CONDITIONS AT JOB SITE AND BE FULLY RESPONSIBLE FOR SAME.

REVISIONS REMARKS TRACED CHECKED

MEP ENGINEER OF RECORD **KJWW ENGINEERING** (tel) (630) 527.2320 (fax) (630) 527.2321 www.kjww.com



State of Illinois Pat Quinn, Governor **COVER SHEET** McHENRY COUNTY COLLEGE

**UPGRADE EXTERIOR LIGHTING** 8900 ROUTE 14 CRYSTAL LAKE, ILL. 60014

**G1.00** 

810-066-016

MARCH 22, 2013

G1.02 AREA OF WORK

SITE PLAN - LOT A - ELECTRICAL DEMOLITION

ELECTRICAL COVER SHEET

SITE PLAN - LOT C - ELECTRICAL DEMOLITION

E1.01 SITE PLAN - LOT A - LIGHTING SITE PLAN - LOT C - LIGHTING

BUILDING A - EXTERIOR LIGHTING REPLACEMENT - ALTERNATE BID #1


BUILDING A, & B - EXTERIOR LIGHTING REPLACEMENT - ALTERNATE BID #1 E2.03 BUILDING C & D - EXTERIOR LIGHTING REPLACEMENT - ALTERNATE BID #1

E2.04 BUILDING E - EXTERIOR LIGHTING REPLACEMENT - ALTERNATE BID #1

ENLARGED ELECTRICAL ROOMS & WIRING DETAILS

ELECTRICAL DETAILS

E4.00 PARTIAL ONE - LINE DIAGRAM

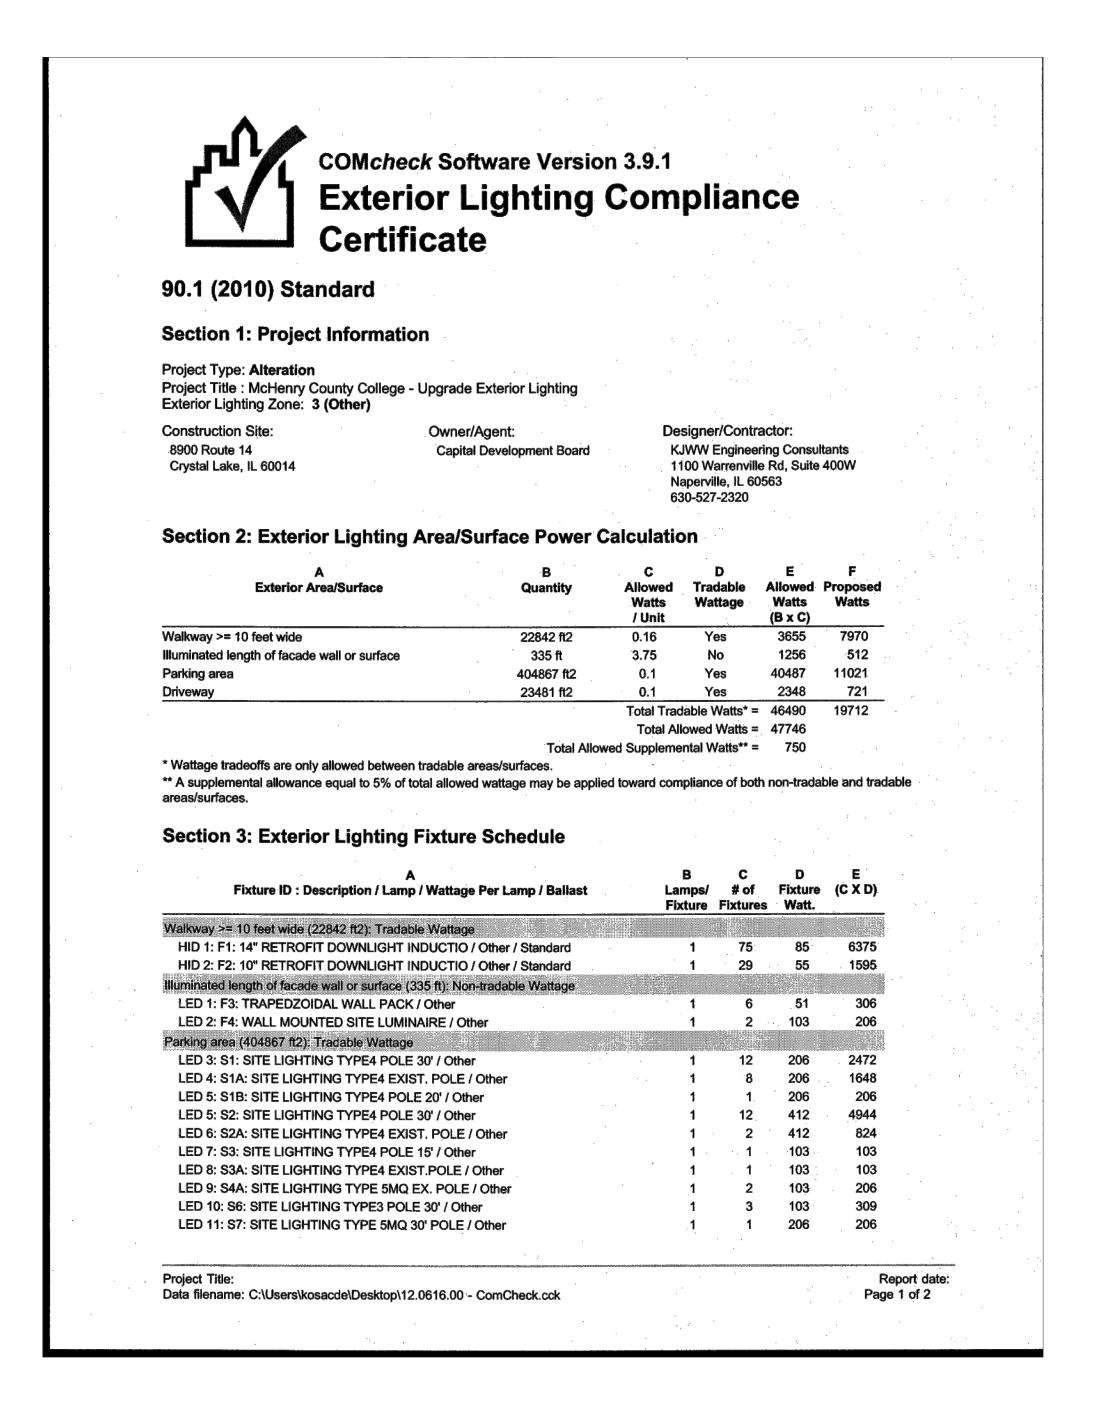


							-
	Lighting Designer or Contrac	ctor Name	Signature		Date		2
Į	1. Construction documen		operating and maintenance	e manuals provided to		· · · · · · · · · · · · · · · · · · ·	
	Section 5: Post Co						
			Sigrature 2	•	Date	٠	
	Standard requirements in CO  TOMASZ BALL  Name - Title	Mcheck Version 3.9.1 and to		y requirements in the I	Requirements  02/14	Checklist.	
	Compliance Statement: The and other calculations submit	ted with this permit application	on. The proposed lighting s	ystem has been desig	ned to meet th	e 90.1 (2010)	tions
;	Section 5: Complia	•					
٠		that is automatically off duri trolled by motion sensor.	ng normal building operatio	on.			
	_	cifically designated as require	•	•	regulation.	: .	
		een claimed as exempt and i					
,	Exceptions:	·				•	
)		ounds luminaires that operate	e at greater than 100W hav	e minimum efficacy of	60 lumen/wat	t.	•
	Exterior Lighting Ef	fficacy:			· · · · · · · · · · · · · · · · · · ·		
/	by 30% during non-op	erating hours or during vaca	ncy periods of <= 15 minut	es.			
ì	directly involved in the 5. Lighting control device	project. s and control systems not as	ssociated with facade or lar	dscaping have control			
	<ul> <li>c. Confirm that photose</li> </ul>	e switches and programmablensor controls reduce electric ts identify the party responsi	c light levels based on the	amount of usable dayli	ght in the spac		t
	photosensors are insta a. Confirm that the place	roper working condition. Whe alled, at a minimum, the follo cement, sensitivity and time-	wing procedures have bee out adjustments for occupa	n performed: int sensors yield accep	table performa		
(	4. Lighting control device		sted to ensure that control	hardware and software			
	Exceptions:						
	3. All lighting fixtures are		or astronomical time switch				
Г	Controls, Switching  2. All exemption claims a		at have a control device in	dependent of the contr	ol of the none	xempt lighting.	
	Controls Switching						
لإ		roposed watts must be less					
`	Lighting Wattage:	ole area/surface, total propos	sed watts must be less than	or equal to total allow	ed watts Acro	oss all tradable	
	xterior Lighting PASSES: I	Design 58% better than code	3.	Marie Committee		March 1987 Car S	_
•	Section 4: Require	ments Checklist					
•				Total Tradable Propo	useu vvalis =	19712	
_		IG TYPE 3 30' POLE / Other		1 2	206	412	
	Driveway (23481 ft2): Tradab LED 12: S5: SITE LIGHTIN	le Wattage IG TYPE2 POLE 30' / Other		. 1 3	103	309	

NOTE: CONTRACTOR SHALL VERIFY ALL DIMENSIONS AND CONDITIONS AT JOB SITE AND BE FULLY RESPONSIBLE FOR SAME.

R		SIONS	DRAWN	PREPARED	MEP ENGINEER OF RECORD
NO.	DATE	REMARKS	nc	<b>DEK</b> OFF.	
			TRACED	APPROVED	
			ТВ	•	KJWW ENGINEERING 1100 Warrenville Road, Suite 400W
			CHECKED	APPROVED	Naperville, Illinois 60563   USA
			JML	•	(tel) (630) 527.2320 (fax) (630) 527.2321 www.kjww.com



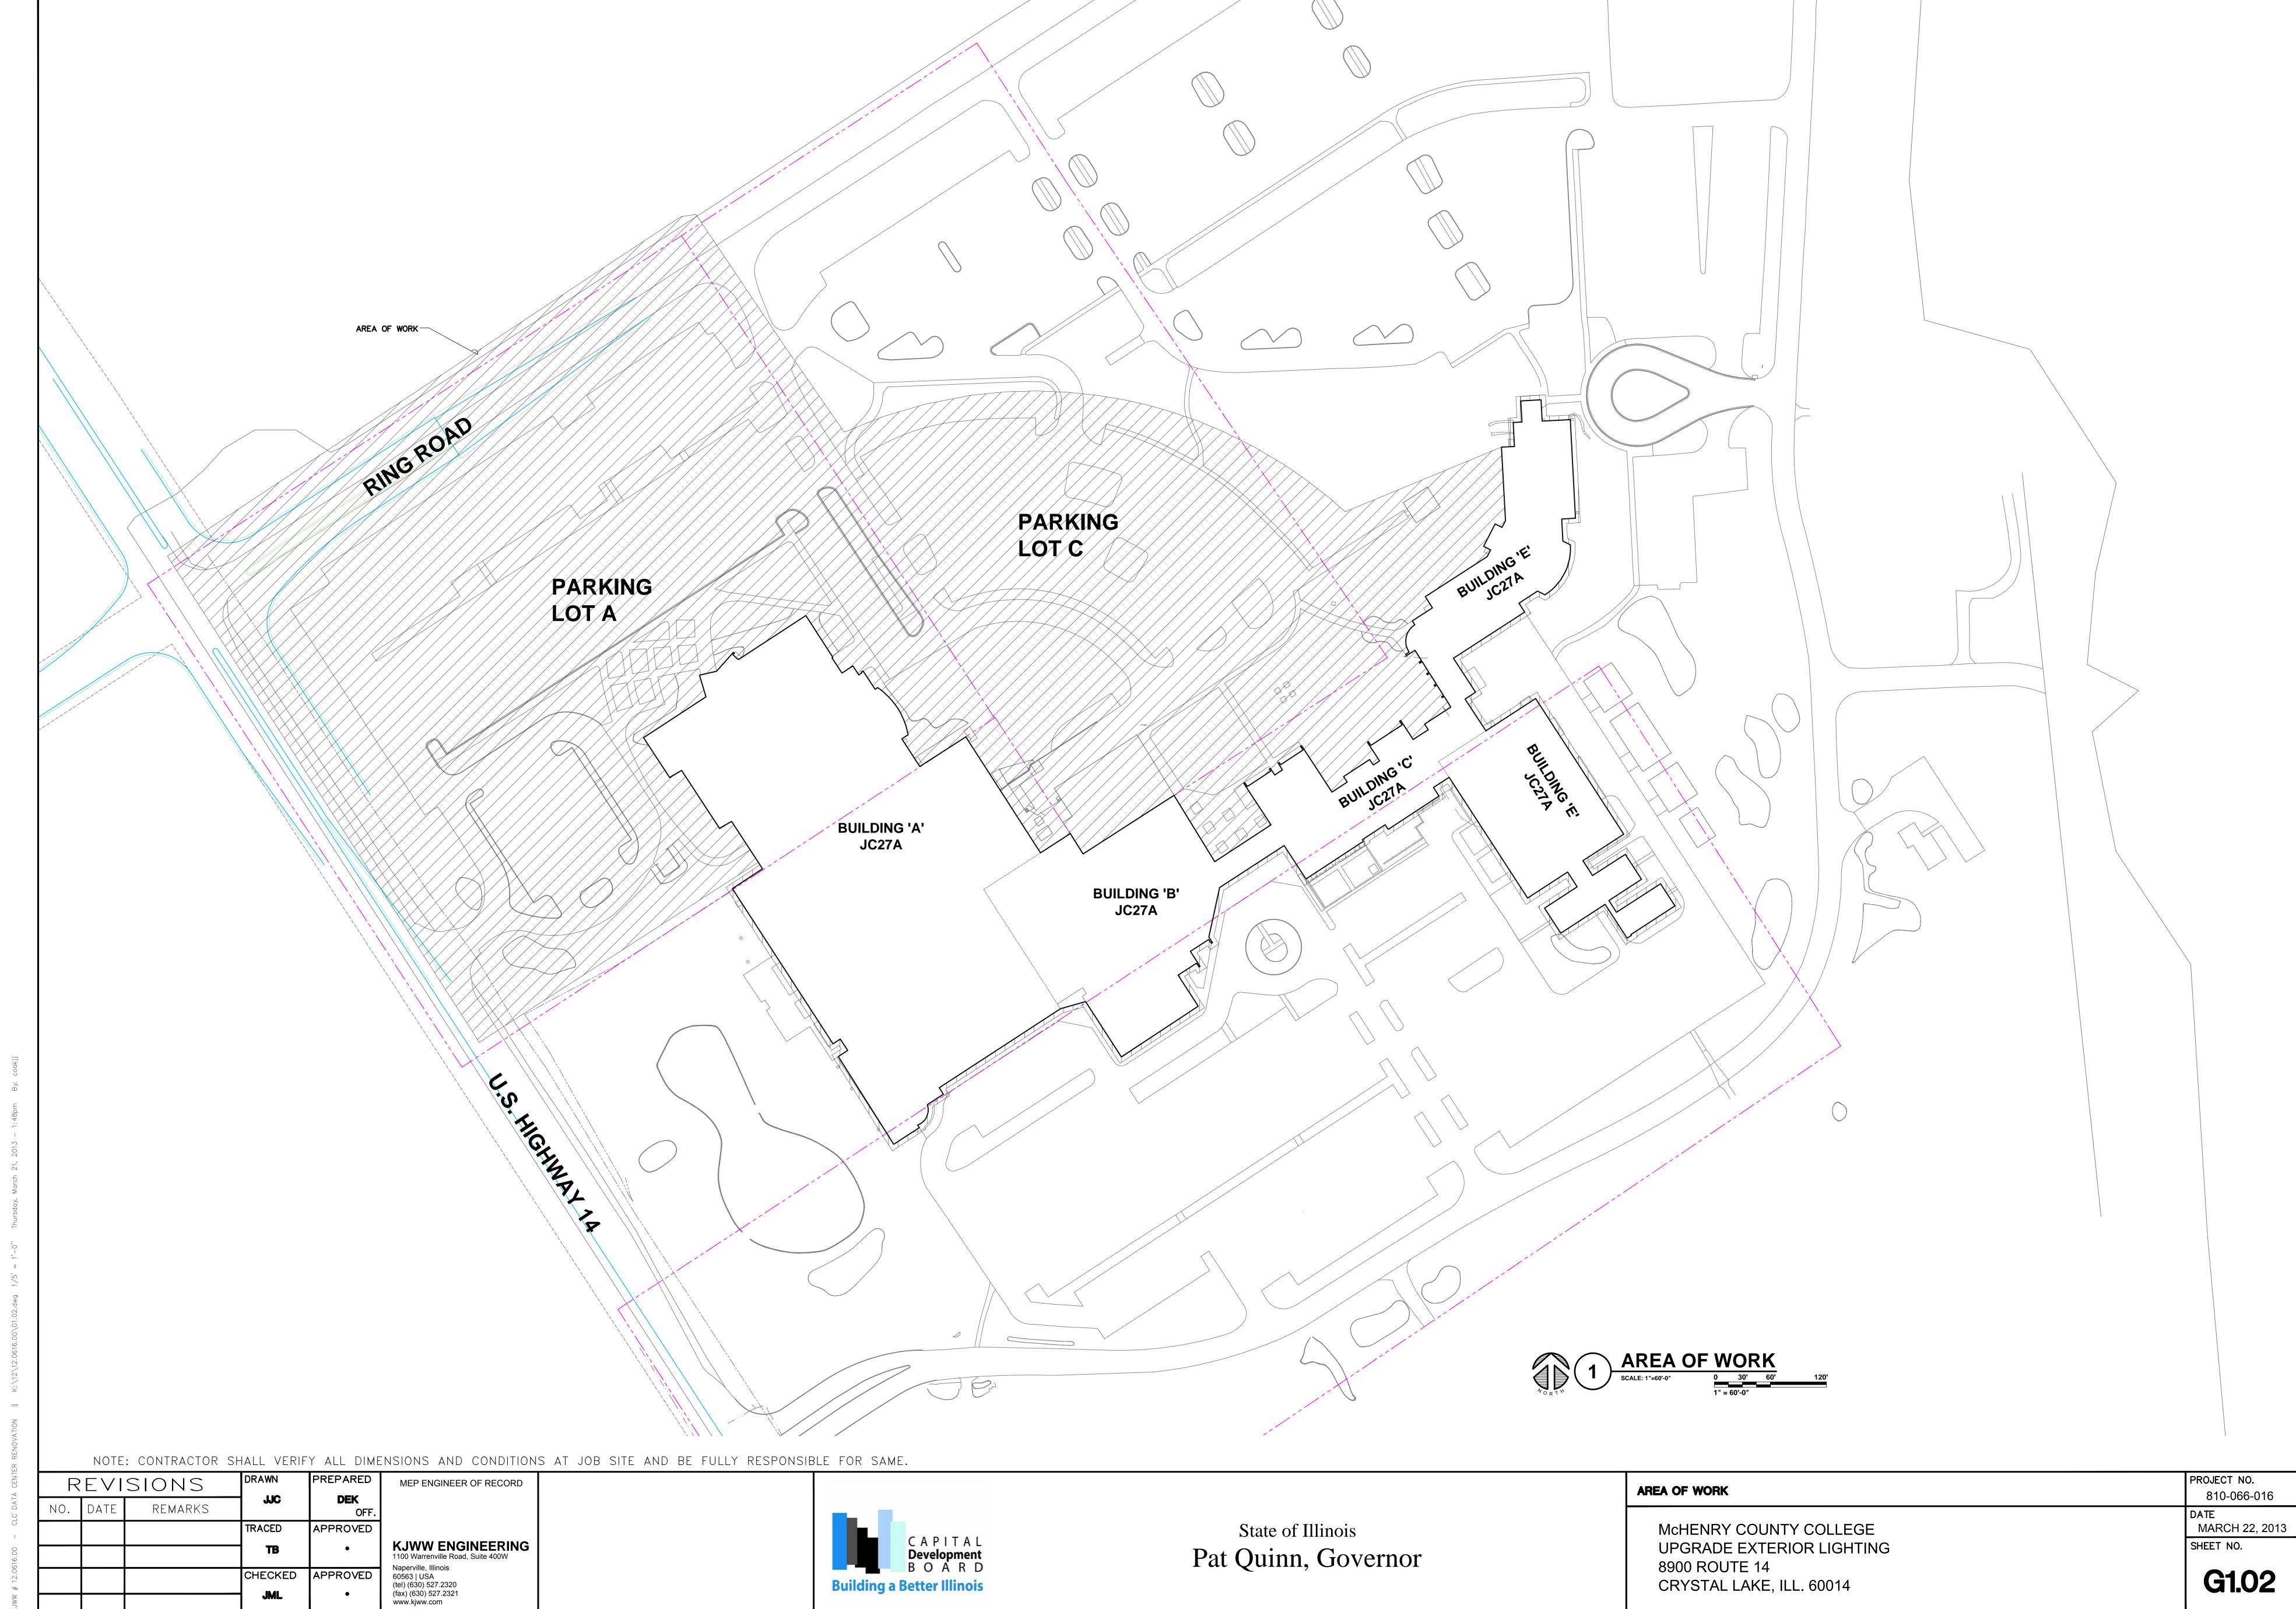

### **ELECTRICAL DEMOLITION NOTES:**

- THE ELECTRICAL DRAWINGS INDICATE EXISTING ELECTRICAL ITEMS TO BE REMOVED. THE DRAWINGS ARE INTENDED TO INDICATE THE SCOPE OF WORK REQUIRED AND DO NOT INDICATE EVERY BOX, CONDUIT, OR WIRE THAT MUST BE REMOVED. THE CONTRACTOR SHALL VISIT THE SITE PRIOR TO SUBMITTING A BID AND VERIFY EXISTING CONDITIONS.
- 2. ELECTRICAL ITEMS (i.e., LIGHTING FIXTURES, ETC.) REMOVED AND NOT RELOCATED REMAIN THE PROPERTY OF THE OWNER. THE CONTRACTOR SHALL BE RESPONSIBLE FOR THE DISPOSAL OF MATERIAL THE OWNER DOES NOT WANT TO REUSE OR RETAIN (i.e., FOR MAINTENANCE PURPOSES).
- 3. THE CONTRACTOR SHALL OBTAIN APPROVAL FROM THE OWNER BEFORE TURNING OFF POWER TO CIRCUITS, FEEDERS, PANELS, ETC. COORDINATE ALL OUTAGES WITH OWNER. CONDUIT CONCEALED IN WALL CONSTRUCTION MAY BE ABANDONED IN PLACE IF NOT AFFECTED BY OTHER CONSTRUCTION.
- 4. EXISTING CONDUIT IN GOOD CONDITION, MAY BE REUSED IN PLACE. RELOCATED EXISTING CONDUIT SHALL NOT BE ALLOWED. BONDING CONDUCTORS SHALL BE INSTALLED IN ALL REUSED CONDUIT TO ASSURE PROPER GROUND PATH.
- 5. EQUIPMENT REMOVAL IN CERTAIN LOCATIONS MAY REQUIRE THE INSTALLATION OF A JUNCTION BOX TO RECONNECT CIRCUITS THAT REMAIN IN OPERATION. EXTEND CONDUIT AND WIRING AS REQUIRED TO MAINTAIN POWER TO REMAINING EQUIPMENT.
- 6. CONTRACTOR SHALL REMOVE AND INSTALL ALL CEILING TILES AS REQUIRED FOR THE EXECUTION OF ELECTRICAL WORK THAT IS OUTSIDE THE CONTRACT LIMITS OF CONSTRUCTION. CONTRACTOR SHALL REPLACE CEILING TILES WITH IDENTICAL MATERIAL WHERE DAMAGED BY THIS CONTRACTOR.
- OF BY A FEDERAL OR STATE E.P.A. APPROVED METHOD AND IN ACCORDANCE WITH SPECIFICATIONS.

7. BALLASTS MANUFACTURED PRIOR TO 1980 CONTAIN PCBs AND SHALL BE DISPOSED

8. HID AND FLUORESCENT LAMPS CONTAIN MERCURY AND SHALL BE DISPOSED OF BY A FEDERAL OR STATE E.P.A. APPROVED METHOD AND IN ACCORDANCE WITH SPECIFICATIONS.

#### **GENERAL ELECTRICAL NOTES:**

- 1. "1/E1.01" INDICATES DETAIL NUMBER/SHEET NUMBER.
- 2. ##-### INDICATES ELECTRICAL EQUIPMENT DEFINED IN ELECTRICAL SCHEDULES. REFER TO DRAWINGS CONTAINING ELECTRICAL SCHEDULES. PERMANENT NAMEPLATE SHALL MATCH FINAL EQUIPMENT NOMENCLATURE, NOT ELECTRICAL EQUIPMENT TAG NAME, REFER TO SPECIFICATIONS.
- 3. INDICATES KEYED NOTE USED TO DESCRIBE ADDITIONAL INFORMATION OF WORK REQUIRED, SPECIFIC TO THE SHEET AND/OR DETAIL IT IS SHOWN WITH.
  - ALL ELECTRICAL CONDUCTORS SHALL BE COPPER.
- 5. INDICATES NUMBER OF WIRES IN CONDUIT. - GROUND WIRE NEUTRAL WIRE PHASE WIRE
  - ABBREVIATION KEY: ELECTRICAL CONTRACTOR E.C. CONDUIT TYPICAL
- LINE TYPE KEY:
- ——— NEW WORK BY THIS CONTRACTOR (DARK SOLID LINE) ---- NEW WORK UNDERFLOOR OR UNDERGROUND BY THIS CONTRACTOR (DARK LONG DASHED LINE)
- NEW WORK BY OTHERS AND/OR EXISTING TO REMAIN (LIGHT SOLID LINE) ----- EXISTING TO BE REMOVED BY THIS CONTRACTOR (DARK SHORT DASHED LINE)

#### **ELECTRICAL INSTALLATION NOTES:**

- 1. CIRCUIT NUMBERS ARE SHOWN FOR CIRCUIT IDENTIFICATION. CIRCUITING SHALL AGREE WITH NUMBERING ON THE PANEL PROVIDED. BALANCE THE LOAD ON PANEL AS EVENLY AS POSSIBLE BETWEEN EACH PHASE.
- CONCEAL ALL CONDUIT IN WALLS, PARTITIONS, ABOVE CEILING, AND BELOW GRADE, ETC. UNLESS OTHERWISE INDICATED ON THE PLANS OR IN THE SPECIFICATIONS. CONDUIT IN MECHANICAL ROOMS, AND STORAGE ROOMS WITHOUT CEILINGS MAY BE EXPOSED ON BUILDING STRUCTURE.
- 3. CONTRACTOR SHALL BE RESPONSIBLE FOR ALL OPENINGS REQUIRED IN WALLS. ALL OPENINGS SHALL BE REPAIRED TO MATCH EXISTING BY A QUALIFIED CONTRACTOR AT THE EXPENSE OF THIS CONTRACTOR. ALL CONDUITS THROUGH WALLS SHALL BE GROUTED OR SEALED INTO OPENINGS.

#### ELECTRICAL DEMOLITION SYMBOLLIST

ELECTR	ELECTRICAL DEMOLITION SYMBOL LIST					
SYMBOL:	DESCRIPTION:					
	INDICATES EXISTING TO REMAIN					
	INDICATES EXISTING TO BE REMOVED.					
	POLE MOUNTED LUMINAIRE - (1) HEAD					
<b>□</b> □	POLE MOUNTED LUMINAIRE - (2) HEAD					
E	ELECTRICAL CONNECTION TO EQUIPMENT					
0	DOWN LIGHT					
	EXTERIOR WALL-PACK LUMINAIRE					
A# C#	LOT LETTER SIGN					
EP	EMERGENCY PHONE STATION					

#### GENERAL ELECTRICAL EQUIPMENT SCHEDULE

THE SYMBOLS AND THE EQUIPMENT SCHEDULE ARE FOR THE CONVENIENCE OF THE CONTRACTOR. EACH CONTRACTOR SHALL BE RESPONSIBLE FOR VERIFICATION OF QUANTITIES AND SHALL FURNISH ALL MATERIAL REQUIRED, WHETHER SPECIFIED OR NOT, TO PRODUCE A SATISFACTORY WORKING SYSTEM.

CATALOG NUMBERS SHALL NOT BE CONSIDERED COMPLETE BUT ARE GIVEN ONLY TO AID THE CONTRACTOR IN THE SEARCH FOR MATERIAL. NO MATERIAL SHALL BE ORDERED BY MANUFACTURER AND CATALOG NUMBER ONLY. EACH CONTRACTOR SHALL FIRST READ THE COMPLETE DESCRIPTION OF THE MATERIAL ON THESE DRAWINGS AND SPECIFICATIONS. THE FIRST MANUFACTURER LISTED IS THE BASIS OF DESIGN. "STANDARD COLOR" INDICATES FACTORY FINISH AVAILABLE AT NO ADDITIONAL CHARGE.

ITEM NO.	SYMBOL	DESCRIPTION	APPROVED MANUFACTURERS
1	<u>IC-1</u> <u>IC-2</u>	TIME SWITCH, 7 DAY, 2 CHANNEL, ELECTRONIC, TWO SPDT 15 AMP CONTACTS, TWO SEPARATE PROGRAMS WITH 16 SET POINTS AVAILABLE, L.C.D. DISPLAY, 12 OR 24 HOUR FORMAT, MINIMUM 100 HOURS CARRY-OVER, U.L. LISTED.	PARAGON EC72 TORK DTS 200A INTERMATIC ET70215C
2	LC-A LC-C LC-ROAD LC-NL A & C	LIGHTING CONTACTOR, ELECTRICALLY HELD, 120 VOLT COIL, 300 VOLT 30 AMP CONTINUOUS CONTACTS, 4 POLE, N.E.M.A. 1 ENCLOSURE.	SQUARE D CLASS 8903 SIEMENS LEN SERIES CUTLER HAMMER CN35DG
3	E E	ELECTRICAL CONNECTION TO EQUIPMENT AND MOTORS, SIZE PER N.E.C. COORDINATE REQUIREMENTS WITH CONTRACTOR FURNISHING EQUIPMENT OR MOTOR. REFER TO SPECIFICATIONS AND GENERAL INSTALLATION NOTES FOR TERMINATIONS TO MOTORS.	REFER TO SPECIFICATIONS
4	PANEL 'SL'	PANELBOARD, SURFACE MOUNT, 480/277 VOLT, 3 PHASE, 4 WIRE, S/N, GROUND BUS, COPPER BUS, BOLT-ON BREAKERS, NEMA 1 ENCLOSURE, REFER TO SCHEDULES FOR SIZE AND CONFIGURATION, REFER TO SPECIFICATIONS FOR ADDITIONAL INFORMATION.	SQUARE D NF SERIES SIEMENS P1 SERIES CUTLER—HAMMER PRL2 SERIES
5	<u>HH-1</u>	HANDHOLE, COMPOSITE POLYMER CONCRETE BODY AND COVER. STAINLESS STEEL HARDWARE. BOLTED NON-SKID COVER RATED FOR 20,000 LB. DESIGN LOAD OCCASIONAL NON-DELIBERATE VEHICULAR TRAFFIC. STACK UNITS TO ACHIEVE DEPTH SHOWN ON PLANS. UNITS IN LANDSCAPED AREAS SHALL BE GREEN IN COLOR. 11"W, 18"L, 18"D OR DIMENSIONS AS SHOWN ON PLANS 'ELECTRICAL'	HUBBELL/QUAZITE PG SERIES CARSON INDUSTRIES H SERIES ARMORCAST HIGHLINE PRODUCTS SYNERTECH
6	HH-2	HANDHOLE, COMPOSITE POLYMER CONCRETE BODY AND COVER. STAINLESS STEEL HARDWARE. BOLTED NON-SKID COVER RATED FOR 20,000 LB. DESIGN LOAD OCCASIONAL NON-DELIBERATE VEHICULAR TRAFFIC. STACK UNITS TO ACHIEVE DEPTH SHOWN ON PLANS. UNITS IN LANDSCAPED AREAS SHALL BE GREEN IN COLOR. 11"W, 18"L, 18"D OR DIMENSIONS AS SHOWN ON PLANS 'TECHNOLOGY"	HUBBELL/QUAZITE PG SERIES CARSON INDUSTRIES H SERIES ARMORCAST HIGHLINE PRODUCTS SYNERTECH

	'ING: (MTG) RECESSED	LAMP TYPI FL-		RESCENT			LENS/LOU A-	-	ACRYLIC
SP-	SUSPENDED CEILING SURFACE	CF-	COMP	ACT FLUC	RES	SCENT	B-	BLACI	K BAFFLE R ALZAK
WL-	WALL UNDER CABINET	LED-	LIGHT	EMITTING	DIO		D-	PARA	BOLIC
CV-	COVE	MH-	METAL	HALIDE		DIOW	G-	TEMP	ERED GLASS
	OTHER (SEE DESCRIPTION)	LV-	LOW V	URY VAPO			P-	POLY	WASHER CARBONATE
OOR:		_		R METAL H START M		DE AL HALIDE			2 .125" ACRYLIC 9 .156" ACRYLIC
	FLAT ALUMINUM FLAT STEEL			R (SEE DE IDED LIFE				LOW I	RIDESCENT SPECULAR ALUM.
	REGRESSED ALUMINUM REGRESSED STEEL	XLP-		IDED LIFE HOURS		OUTPUT O LUMENS			IMPACT DR ACRYLIC R (SEE DESCRIPTION)
NISH:		BALLAST: DIM-		NG BALLA	ST				AST FACTOR / LOW LEVEL BALLAST
	PAINT AFTER FABRICATION FINISH SELECTION BY ARCHITECT	1		RONIC BA		AST ERY/BALLAST	HP-	HIGH	PERFORMANCE I-LEVEL SWITCHING
	OG NUMBER SHALL NOT BE CONSIDERED COMPLETE	DALI-	DIGITA	L DIMMIN	IG B	ALLAST	MV-	MULT	I-VOLTAGE ELECTRONIC
OMPL	ETE DESCRIPTION AND THE SPECIFICATION SHALL B SORIES TO BE ORDERED. THE FIRST MANUFACTURE	E COORDIN	ATED W	/ITH THE (	CAT	ALOG NUMBER			
	MDS FOR THE PROJECT SHALL BE ELIRABELED AND INC.	IOTAL I ED D	V THE E	TI FOTDIO	۸۱ ۵	CONTRACTOR U	II FOO OTH		E NOTED
	MPS FOR THIS PROJECT SHALL BE FURNISHED AND IN CORRELATED COLOR TEMPERATURE 4000°K, COLOR F								
TEM	DESCRIPTION	SIZE	MTG	TYPE	_	AMPS UANTITY & SIZE	VOLTS / BLS	L/L	APPROVED MANUFACTURER
S1	SITE LIGHTING LUMINAIRE, SINGLE HEAD, DIE-CAST ALUMINUM HOUSING, INJECTION MOLDED ACRYLIC OPTICS, TYPE 4 DISTRIBUTION, LED DRIVER, 10kV TRANSIENT LINE SURGE PROTECTOR, BRONZE FINISH.  POLE: 30' HEIGHT, 6" SQUARE STRAIGHT	15 1/2" W 28 3/4" L 4" H	PL	LED	1	206 WATT	277V	0	MCGRAW-EDISON GLEON-AA-04-E1-T4 BETA LIGHTING ARE-EDG-4M-DA-20-D-UL LITHONIA DSX2 LED
	ALUMINUM WITH INTERNAL VIBRATION DAMPER								
S1A	SIMILAR TO S1, ATTACH POLE TO EXISTING POLE BASE, VERIFY EXISTING BOLT PATTERN PRIOR TO ORDERING.	15 1/2" W 28 3/4" L 4" H	PL	LED	1	206 WATT	277V	0	REFER TO S1
S1B	SIMILAR TO S1, WITH 20' HEIGHT POLE, 4" SQUARE STRAIGHT, ATTACH POLE TO EXISTING POLE BASE, VERIFY EXISTING BOLT PATTERN PRIOR TO ORDERING.	15 1/2" W 28 3/4" L 4" H	PL	LED	1	206 WATT	277V	0	REFER TO S1
S2	SITE LIGHTING LUMINAIRE, DUAL HEADS, DIE-CAST ALUMINUM HOUSING, INJECTION MOLDED ACRYLIC OPTICS, TYPE 4 DISTRIBUTION, LED DRIVER, 10kV TRANSIENT LINE SURGE PROTECTOR, BRONZE FINISH.	15 1/2" W 28 3/4" L 4" H	PL	LED	2	206 WATT	277V	0	MCGRAW-EDISON GLEON-AA-04-E1-T4 BETA LIGHTING ARE-EDG-4M-DA-20-D-UL LITHONIA DSX2 LED
	POLE: 30' HEIGHT, 6" SQUARE STRAIGHT ALUMINUM WITH INTERNAL VIBRATION DAMPER								
52A	SIMILAR TO S2, ATTACH POLE TO EXISTING POLE BASE, VERIFY EXISTING BOLT PATTERN PRIOR TO ORDERING.	15 1/2" W 28 3/4" L 4" H	PL	LED	2	206 WATT	277V	0	REFER TO S2
S3	SITE LIGHTING LUMINAIRE, SINGLE HEAD, DIE-CAST ALUMINUM HOUSING, INJECTION MOLDED ACRYLIC OPTICS, TYPE 4 DISTRIBUTION, LED DRIVER, 10kV TRANSIENT LINE SURGE PROTECTOR, BRONZE FINISH.	15 1/2" W 28 3/4" L 4" H	PL	LED	1	103 WATT	277V	0	MCGRAW-EDISON GLEON-AA-02-E1-T4 BETA LIGHTING ARE-EDG-4M-DA-10-D-UL LITHONIA DSX1 LED
	POLE: 15' HEIGHT, 4" SQUARE STRAIGHT ALUMINUM								
53A	SIMILAR TO S3, ATTACH TO EXISTING POLE. PROVIDE ALL REQUIRED MOUNTING HARDWARE	15 1/2" W 28 3/4" L 4" H	PL	LED	1	103 WATT	277V	0	REFER TO S3
S4A	SITE LIGHTING LUMINAIRE, SINGLE HEAD, DIE-CAST ALUMINUM HOUSING, INJECTION MOLDED ACRYLIC OPTICS, TYPE 5MQ DISTRIBUTION, LED DRIVER, 10kV TRANSIENT LINE SURGE PROTECTOR, BRONZE FINISH. ATTACH TO EXISTING POLE. PROVIDE ALL REQUIRED MOUNTING HARDWARE.	15 1/2" W 28 3/4" L 4" H	PL	LED	1	103 WATT	277V	0	MCGRAW-EDISON GLEON-AA-02-E1-5MQ BETA LIGHTING ARE-EDG-5M-DA-10-D-UL LITHONIA DSX1 LED
S5	SITE LIGHTING LUMINAIRE, SINGLE HEAD, DIE-CAST ALUMINUM HOUSING, INJECTION MOLDED ACRYLIC OPTICS, TYPE 2 DISTRIBUTION, LED DRIVER, 10kV TRANSIENT LINE SURGE PROTECTOR, BRONZE FINISH.  POLE: 30' HEIGHT, 6" SQUARE STRAIGHT	15 1/2" W 28 3/4" L 4" H	PL	LED	1	103 WATT	277V	0	MCGRAW-EDISON GLEON-AA-02-E1-T2 BETA LIGHTING ARE-EDG-2M-DA-10-D-UL LITHONIA DSX1 LED
 S6	ALUMINUM WITH INTERNAL VIBRATION DAMPER, BREAKAWAY TRANSFORMER BASE.  SITE LIGHTING LUMINAIRE, SINGLE HEAD, DIE-CAST	15 1/2" W	PL	LED	1	103 WATT	277V	0	MCGRAW-EDISON
	ALUMINUM HOUSING, INJECTION MOLDED ACRYLIC OPTICS, TYPE 3 DISTRIBUTION, LED DRIVER, 10kV TRANSIENT LINE SURGE PROTECTOR, BRONZE FINISH.	28 3/4" L 4" H				100 11111	2777		GLEON-AA-02-E1-T3 BETA LIGHTING ARE-EDG-3M-DA-10-D-UL LITHONIA
	POLE: 30' HEIGHT, 6" SQUARE STRAIGHT ALUMINUM WITH INTERNAL VIBRATION DAMPER								DSX1 LED
S7	SITE LIGHTING LUMINAIRE, SINGLE HEAD, DIE-CAST ALUMINUM HOUSING, INJECTION MOLDED ACRYLIC OPTICS, TYPE 5WQ DISTRIBUTION, LED DRIVER, 10kV TRANSIENT LINE SURGE PROTECTOR, BRONZE FINISH.	15 1/2" W 28 3/4" L 4" H	PL	LED	1	206 WATT	277V	0	MCGRAW-EDISON GLEON-AA-04-E1-5WQ BETA LIGHTING ARE-EDG-5M-DA-20-D-UL LITHONIA DSX2 LED
	POLE: 30' HEIGHT, 6" SQUARE STRAIGHT ALUMINUM WITH INTERNAL VIBRATION DAMPER								
S8	SITE LIGHTING LUMINAIRE, SINGLE HEAD, DIE-CAST ALUMINUM HOUSING, INJECTION MOLDED ACRYLIC OPTICS, TYPE 3 DISTRIBUTION, LED DRIVER, 10kV TRANSIENT LINE SURGE PROTECTOR, BRONZE FINISH.	15 1/2" W 28 3/4" L 4" H	PL	LED	1	206 WATT	277V	0	MCGRAW-EDISON GLEON-AA-04-E1-T3 BETA LIGHTING ARE-EDG-3M-DA-20-D-UL LITHONIA DSX2 LED
	POLE: 30' HEIGHT, 6" SQUARE STRAIGHT ALUMINUM WITH INTERNAL VIBRATION DAMPER, BREAKAWAY TRANSFORMER BASE.								
	CUSTOM OPEN RETROFIT TYPE DOWNLIGHT, 14" EXISTING OPENING, INDUCTION LAMP AND REMOTE MOUNTED BALLAST, ALUMINUM SPECULAR REFLECTOR, 4000K COLOR TEMPERATURE, ETL LISTED, SUITABLE FOR DAMP LOCATION, 4 FT. WIRE/CONDUIT WHIP, PROVIDE MOCKUP PRIOR TO PURCHASE.	15.75" DIA 15" H	RE	0	1	85 WATT	277V	0	ESCO LIGHTING CUSTOM RETRO-FIT SPECTRUM LIGHTING CUSTOM RETRO-FIT SERIES ECLIPSE CUSTOM RETRO-FIT
F2	CUSTOM OPEN RETROFIT TYPE DOWNLIGHT, 10" EXISTING OPENING, INDUCTION LAMP AND REMOTE MOUNTED BALLAST, ALUMINUM SPECULAR REFLECTOR, 4000K COLOR TEMPERATURE, ETL LISTED, SUITABLE FOR DAMP LOCATION, 4 FT. WIRE/CONDUIT WHIP, PROVIDE MOCKUP PRIOR TO PURCHASE.	11" DIA 15" H	RE	0	1	55 WATT	277V	0	ESCO LIGHTING CUSTOM RETRO-FIT SPECTRUM LIGHTING CUSTOM RETRO-FIT SERIES ECLIPSE CUSTOM RETRO-FIT
F3	TRAPEDZOIDAL WALL PACK, DIE-CAST ALUMINUM,	16 1/2" W	WL	LED	1	51 WATT	277V	0	MCGRAW-EDISON
гэ	LED LIGHTBAR, TYPE 3 DISTRIBUTION, BRONZE FINISH.	9" L 7" H					2777		IST-B02-LED-E1-BL3-BZ LITHONIA

LUMINAIRE SCHEDULE

NOTE: CONTRACTOR SHALL VERIFY ALL DIMENSIONS AND CONDITIONS AT JOB SITE AND BE FULLY RESPONSIBLE FOR SAME.

	NOTE	: CUNTRACTOR S	HALL VERIF	Y ALL DIME
R	EVI	SIONS	DRAWN	PREPARED
NO.	DATE	REMARKS	] MC	<b>DEK</b> OFF.
			TRACED	APPROVED
			ТВ	•
			CHECKED	APPROVED
			JML	•
		REVI	REVISIONS	NO. DATE REMARKS  TRACED  TB  CHECKED





State of Illinois Pat Quinn, Governor McHENRY COUNTY COLLEGE

F4 SITE LIGHTING LUMINAIRE, SINGLE HEAD, DIE-CAST 15 1/2" W WL LED

ALUMINUM HOUSING, INJECTION MOLDED ACRYLIC 28 3/4" L

OPTICS, TYPE 4 DISTRIBUTION, LED DRIVER, 10kV

TRANSIENT LINE SURGE PROTECTOR, BRONZE

FINISH. WALL MOUNTING HARDWARE

UPGRADE EXTERIOR LIGHTING 8900 ROUTE 14 CRYSTAL LAKE, ILL. 60014

**ELECTRICAL COVER SHEET** 

810-066-016 MARCH 22, 2013 SHEET NO.

PROJECT NO.


O MCGRAW-EDISON


LITHONIA DSX1 LED

BETA LIGHTING

GLEON-AA-02-E1-T4

ARE-EDG-4M-DA-10-D-UL

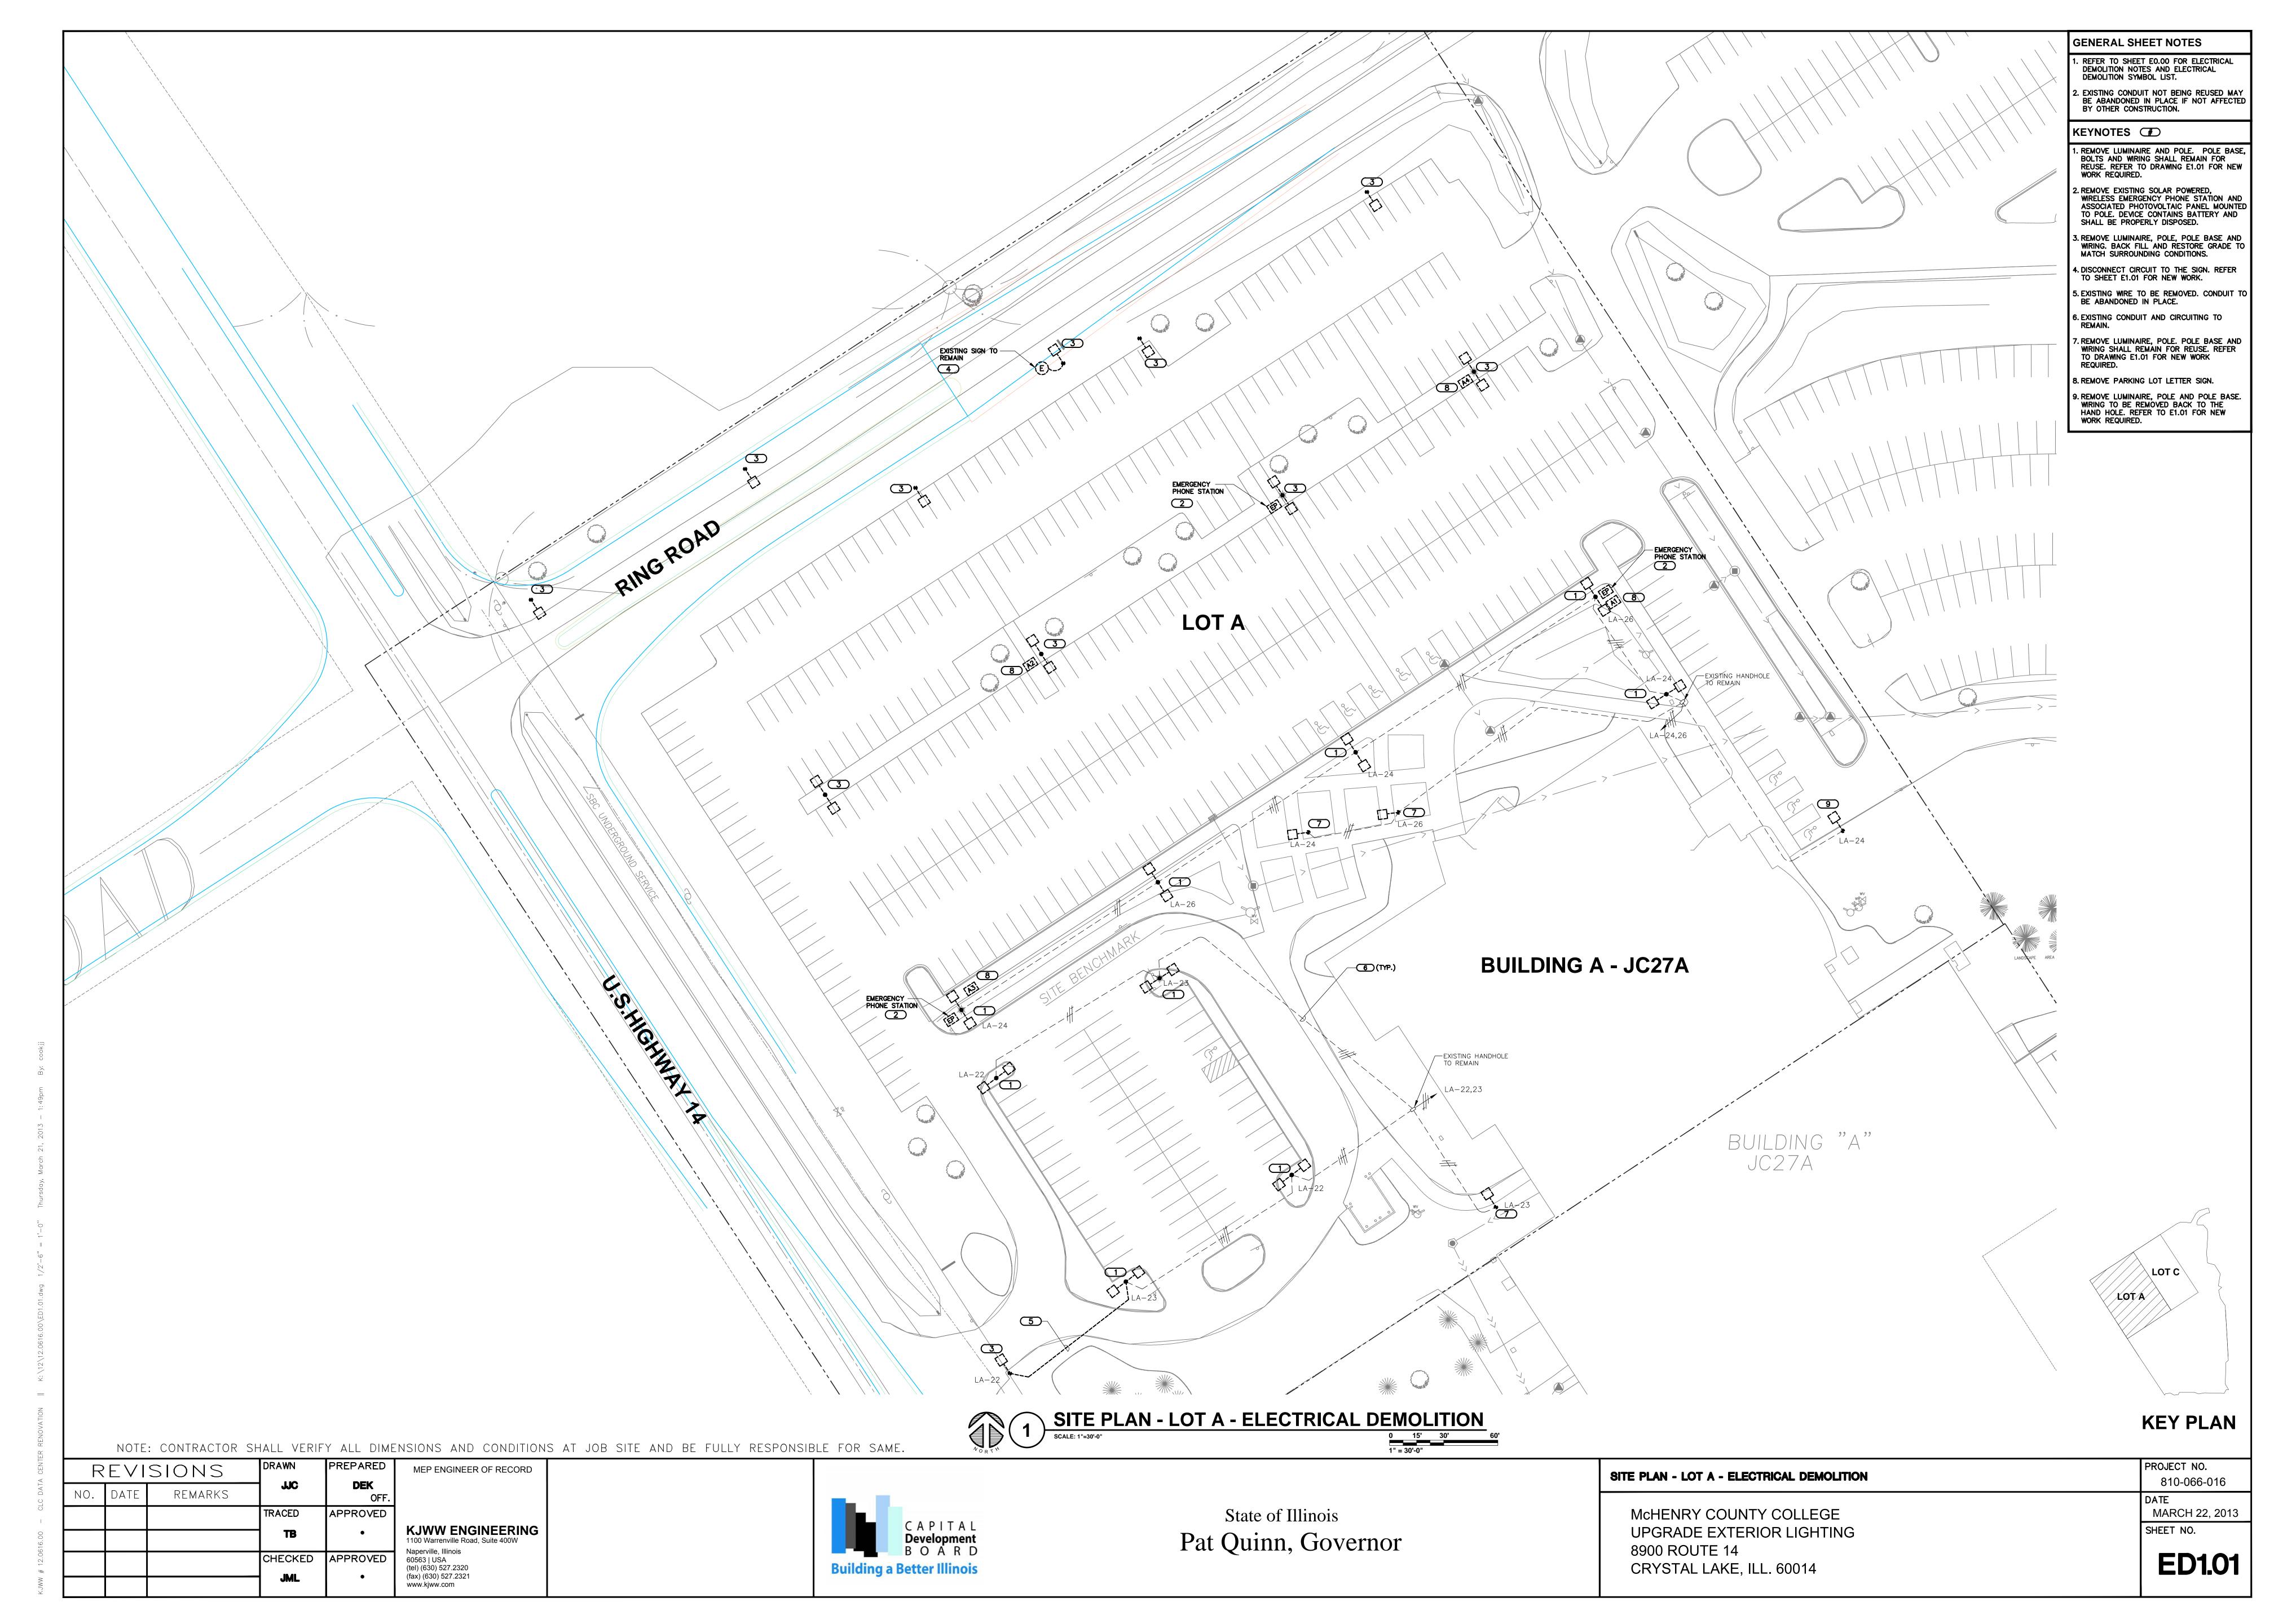

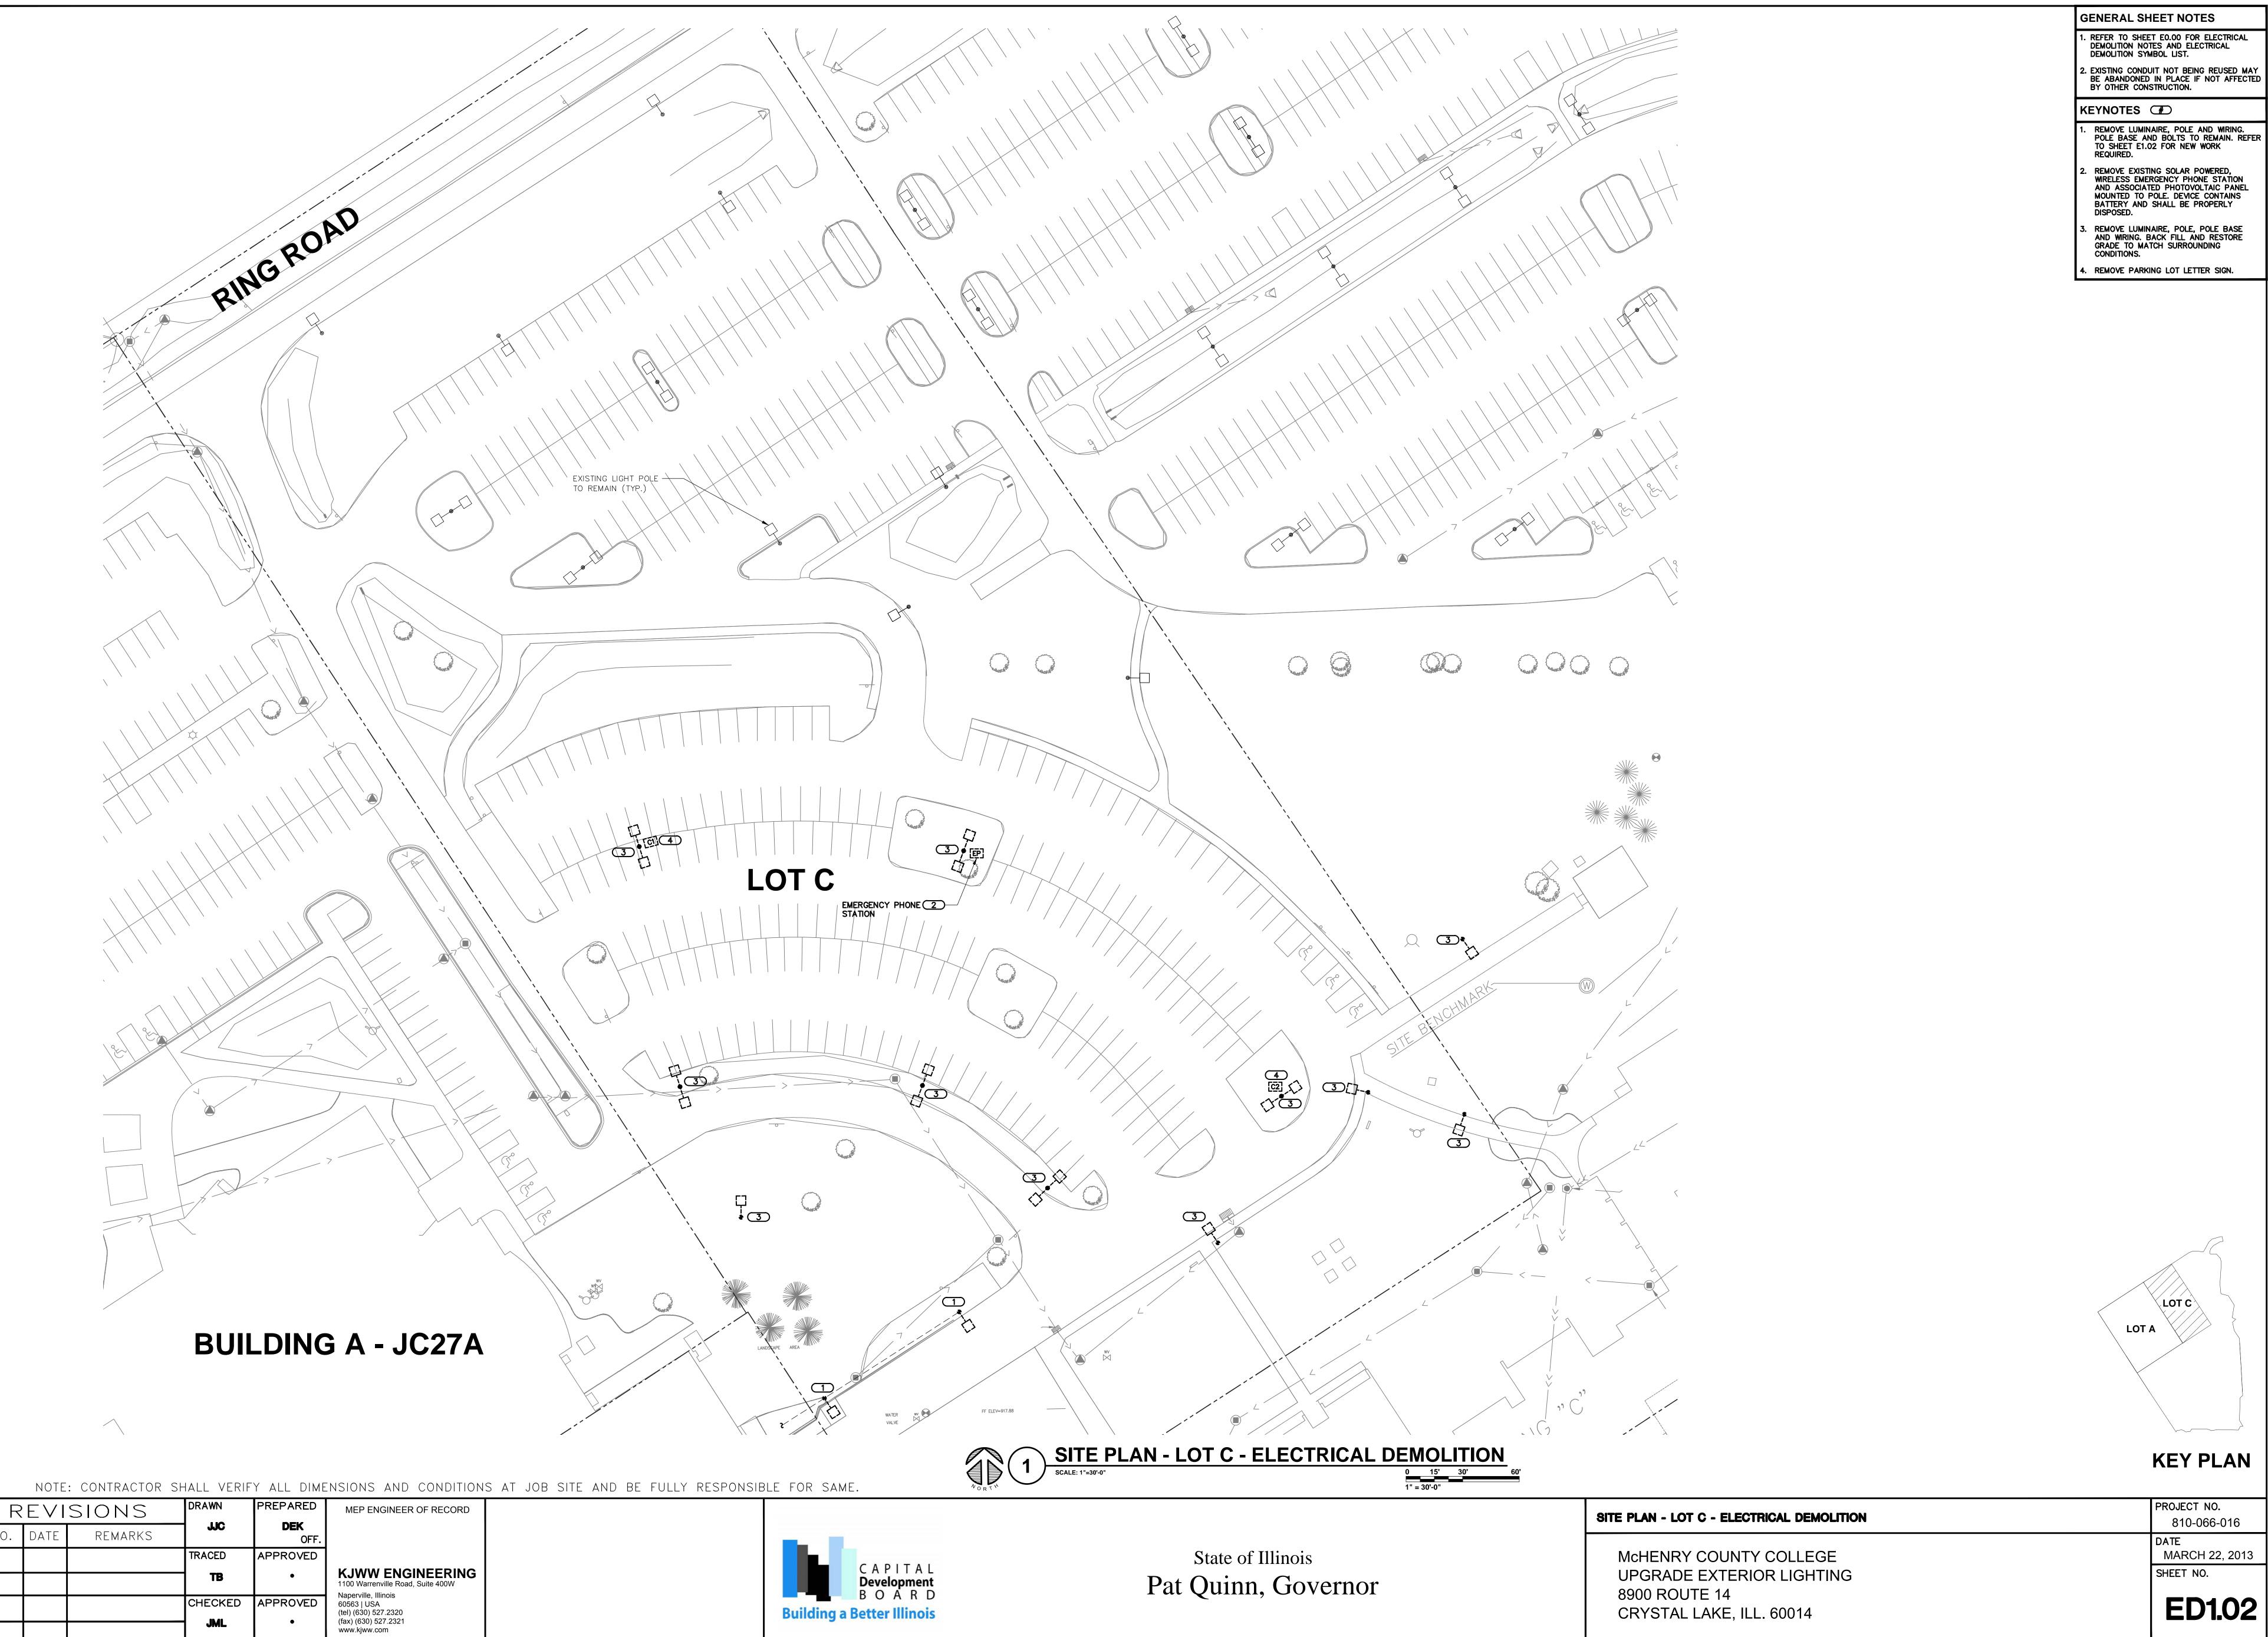

**Building a Better Illinois** 

CHECKED

GENERAL SHEET NOTES

2. EXISTING CONDUIT NOT BEING REUSED MAY BE ABANDONED IN PLACE IF NOT AFFECTED BY OTHER CONSTRUCTION.

2. REMOVE EXISTING SOLAR POWERED, WRELESS EMERGENCY PHONE STATION AND ASSOCIATED PHOTOVOLTAIC PANEL MOUNTED TO POLE. DEVICE CONTAINS BATTERY AND SHALL BE PROPERLY DISPOSED.

REMOVE LUMINAIRE, POLE, POLE BASE AND WRING. BACK FILL AND RESTORE GRADE TO MATCH SURROUNDING CONDITIONS.

REMOVE PARKING LOT LETTER SIGN.


PROJECT NO.


CRYSTAL LAKE, ILL. 60014

810-066-016 MARCH 22, 2013

SHEET NO.

**ED1.02** 

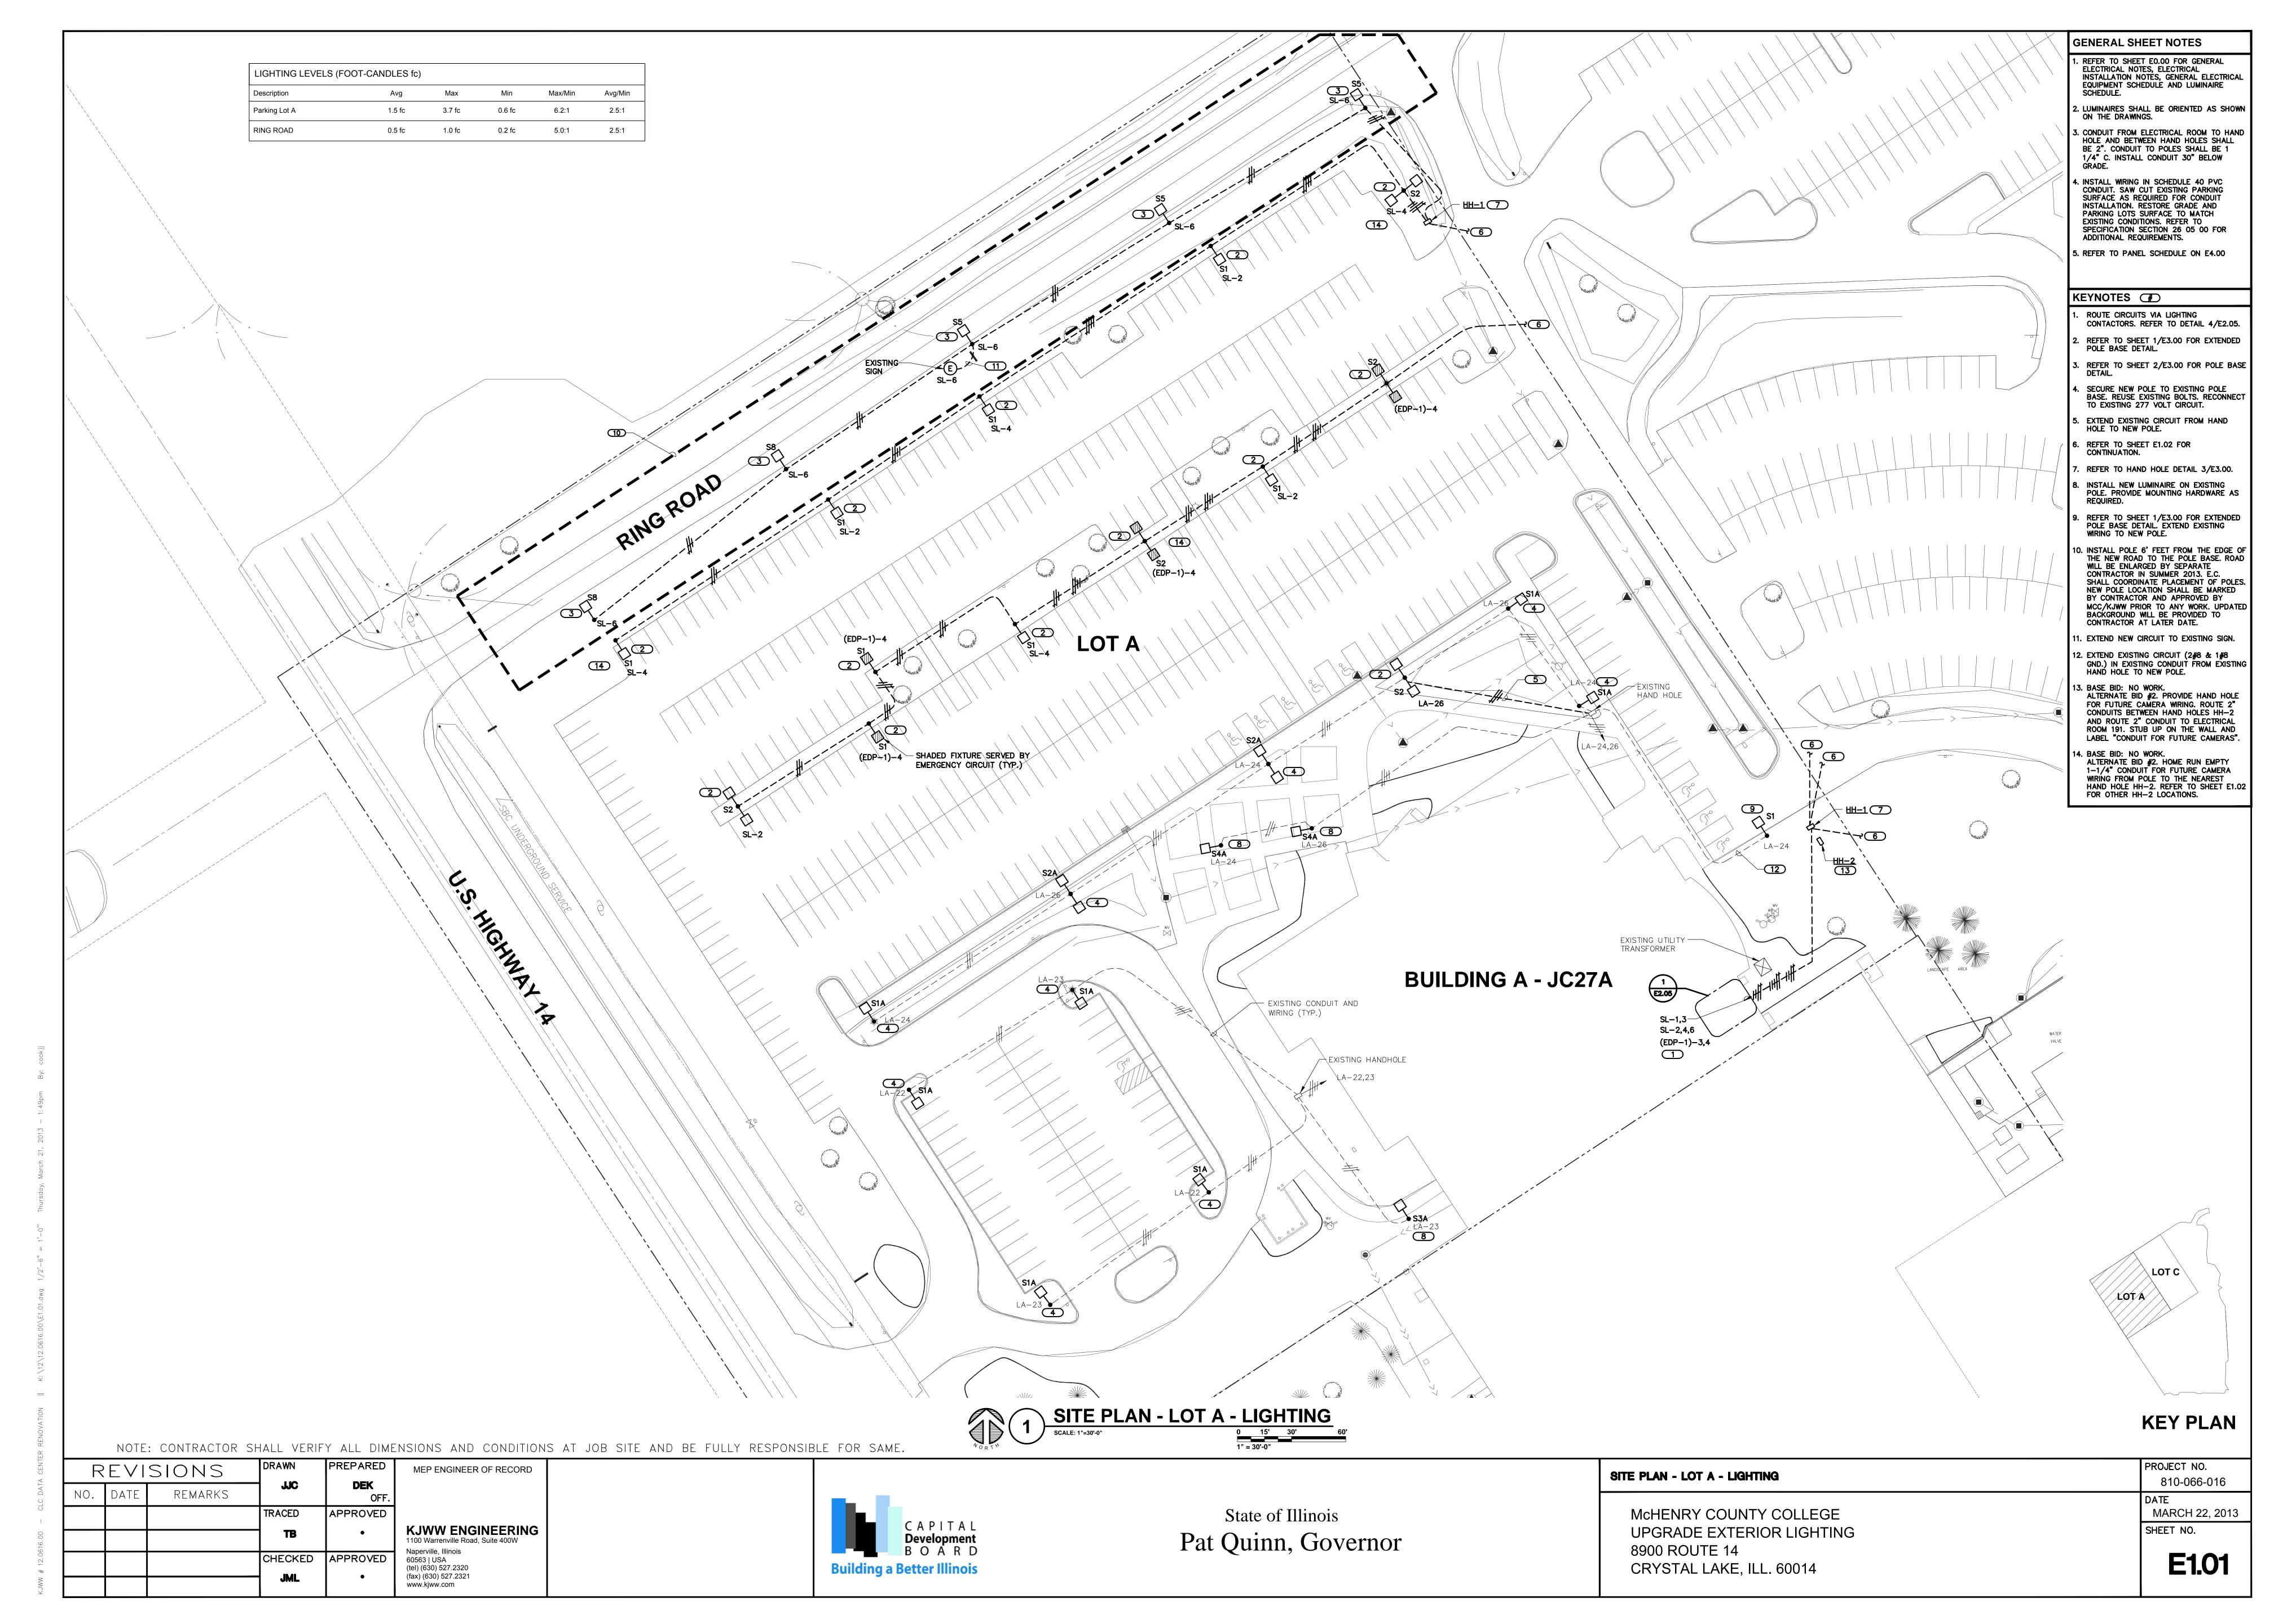

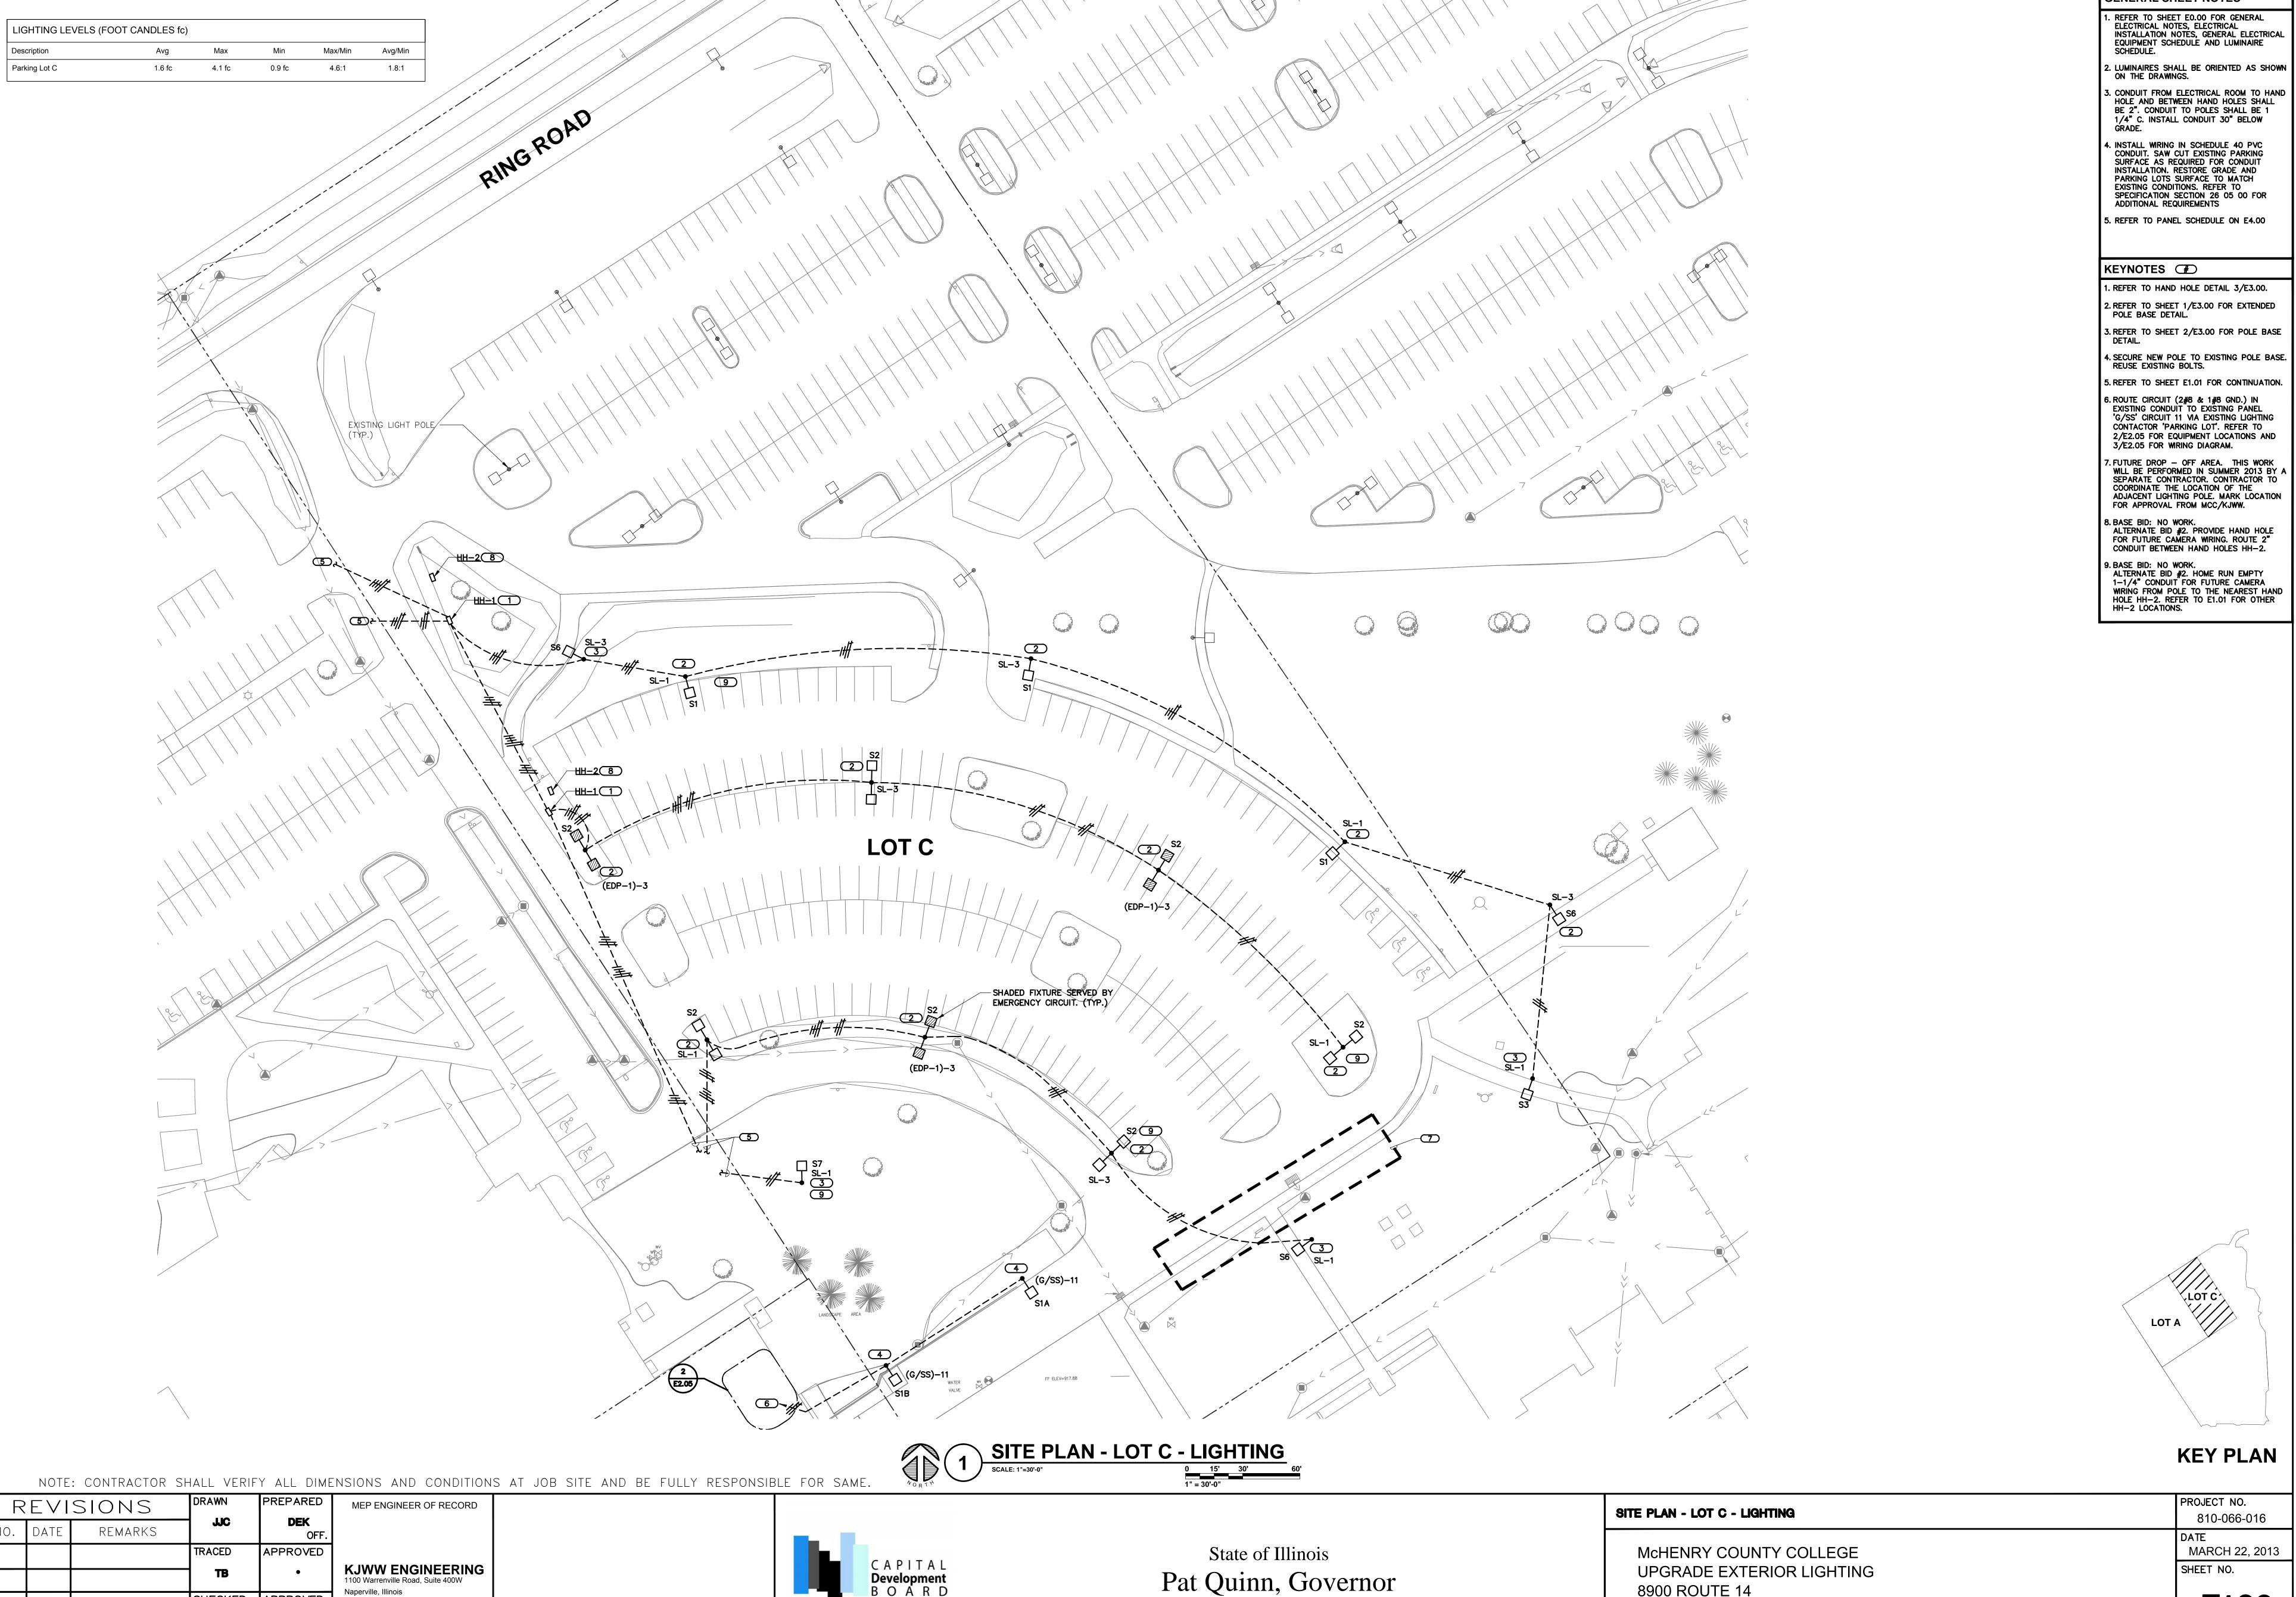

**Building a Better Illinois** 

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**GENERAL SHEET NOTES** 

3. CONDUIT FROM ELECTRICAL ROOM TO HAND HOLE AND BETWEEN HAND HOLES SHALL BE 2". CONDUIT TO POLES SHALL BE 1 1/4" C. INSTALL CONDUIT 30" BELOW

4. INSTALL WIRING IN SCHEDULE 40 PVC CONDUIT. SAW CUT EXISTING PARKING SURFACE AS REQUIRED FOR CONDUIT INSTALLATION. RESTORE GRADE AND PARKING LOTS SURFACE TO MATCH EXISTING CONDITIONS. REFER TO SPECIFICATION SECTION 26 05 00 FOR ADDITIONAL REQUIREMENTS

1. REFER TO HAND HOLE DETAIL 3/E3.00.

6. ROUTE CIRCUIT (2#8 & 1#8 GND.) IN EXISTING CONDUIT TO EXISTING PANEL 'G/SS' CIRCUIT 11 VIA EXISTING LIGHTING

7. FUTURE DROP — OFF AREA. THIS WORK WILL BE PERFORMED IN SUMMER 2013 BY A SEPARATE CONTRACTOR. CONTRACTOR TO COORDINATE THE LOCATION OF THE ADJACENT LIGHTING POLE. MARK LOCATION FOR APPROVAL FROM MCC/KJWW.

8. BASE BID: NO WORK.
ALTERNATE BID #2. PROVIDE HAND HOLE
FOR FUTURE CAMERA WIRING. ROUTE 2"
CONDUIT BETWEEN HAND HOLES HH-2.

9. BASE BID: NO WORK.
ALTERNATE BID #2. HOME RUN EMPTY
1-1/4" CONDUIT FOR FUTURE CAMERA
WRING FROM POLE TO THE NEAREST HAND
HOLE HH-2. REFER TO E1.01 FOR OTHER
HH-2 LOCATIONS.

LOT A

**KEY PLAN** 

810-066-016

8900 ROUTE 14

CRYSTAL LAKE, ILL. 60014

MARCH 22, 2013 SHEET NO.

E1.02

2. DOWNLIGHTS ARE LOCATED IN THE FIRST AND SECOND FLOOR SOFFIT. KEYNOTES (#) 1. REMOVE EXISTING WALL PACK AND REPLACE WITH NEW. RECONNECT TO EXISTING 277 VOLT CIRCUIT. 2. REMOVE EXISTING 175W OR 250 MERCURY VAPOR DOWN-LIGHT INCLUDING BALLAST AND REPLACE WITH NEW. RECONNECT NEW DOWNLIGHT TO EXISTING 277 VOLT CIRCUIT. DOWNLIGHTS ARE ONLY ACCESSIBLE FROM BELOW. INSTALL REMOTE BALLAST ABOVE THE SOFFIT NEXT TO THE DOWNLIGHT. - EXISTING DOWNLIGHT TO REMAIN (TYP.) **BUILDING A - JC27A** ① • F3 BUILDING A - EXTERIOR LIGHTING REPLACEMENT - ALTERNATE BID #1

SCALE: 1/16"=1'-0"

0 8' 16' 32' **KEY PLAN** NOTE: CONTRACTOR SHALL VERIFY ALL DIMENSIONS AND CONDITIONS AT JOB SITE AND BE FULLY RESPONSIBLE FOR SAME. PROJECT NO. MEP ENGINEER OF RECORD

State of Illinois

Pat Quinn, Governor

CAPITAL **Development** BOARD

**Building a Better Illinois** 

GENERAL SHEET NOTES

BUILDING A - EXTERIOR LIGHTING REPLACEMENT - ALTERNATE BID #1

McHENRY COUNTY COLLEGE

CRYSTAL LAKE, ILL. 60014

8900 ROUTE 14

UPGRADE EXTERIOR LIGHTING

1. REFER TO SHEET E0.00 FOR ELECTRICAL DEMOLITION NOTES, ELECTRICAL DEMOLITION SYMBOL LIST, GENERAL ELECTRICAL NOTES AND LUMINAIRE SCHEDULE.

810-066-016

MARCH 22, 2013

**E2.01** 

SHEET NO.

REVISIONS

REMARKS


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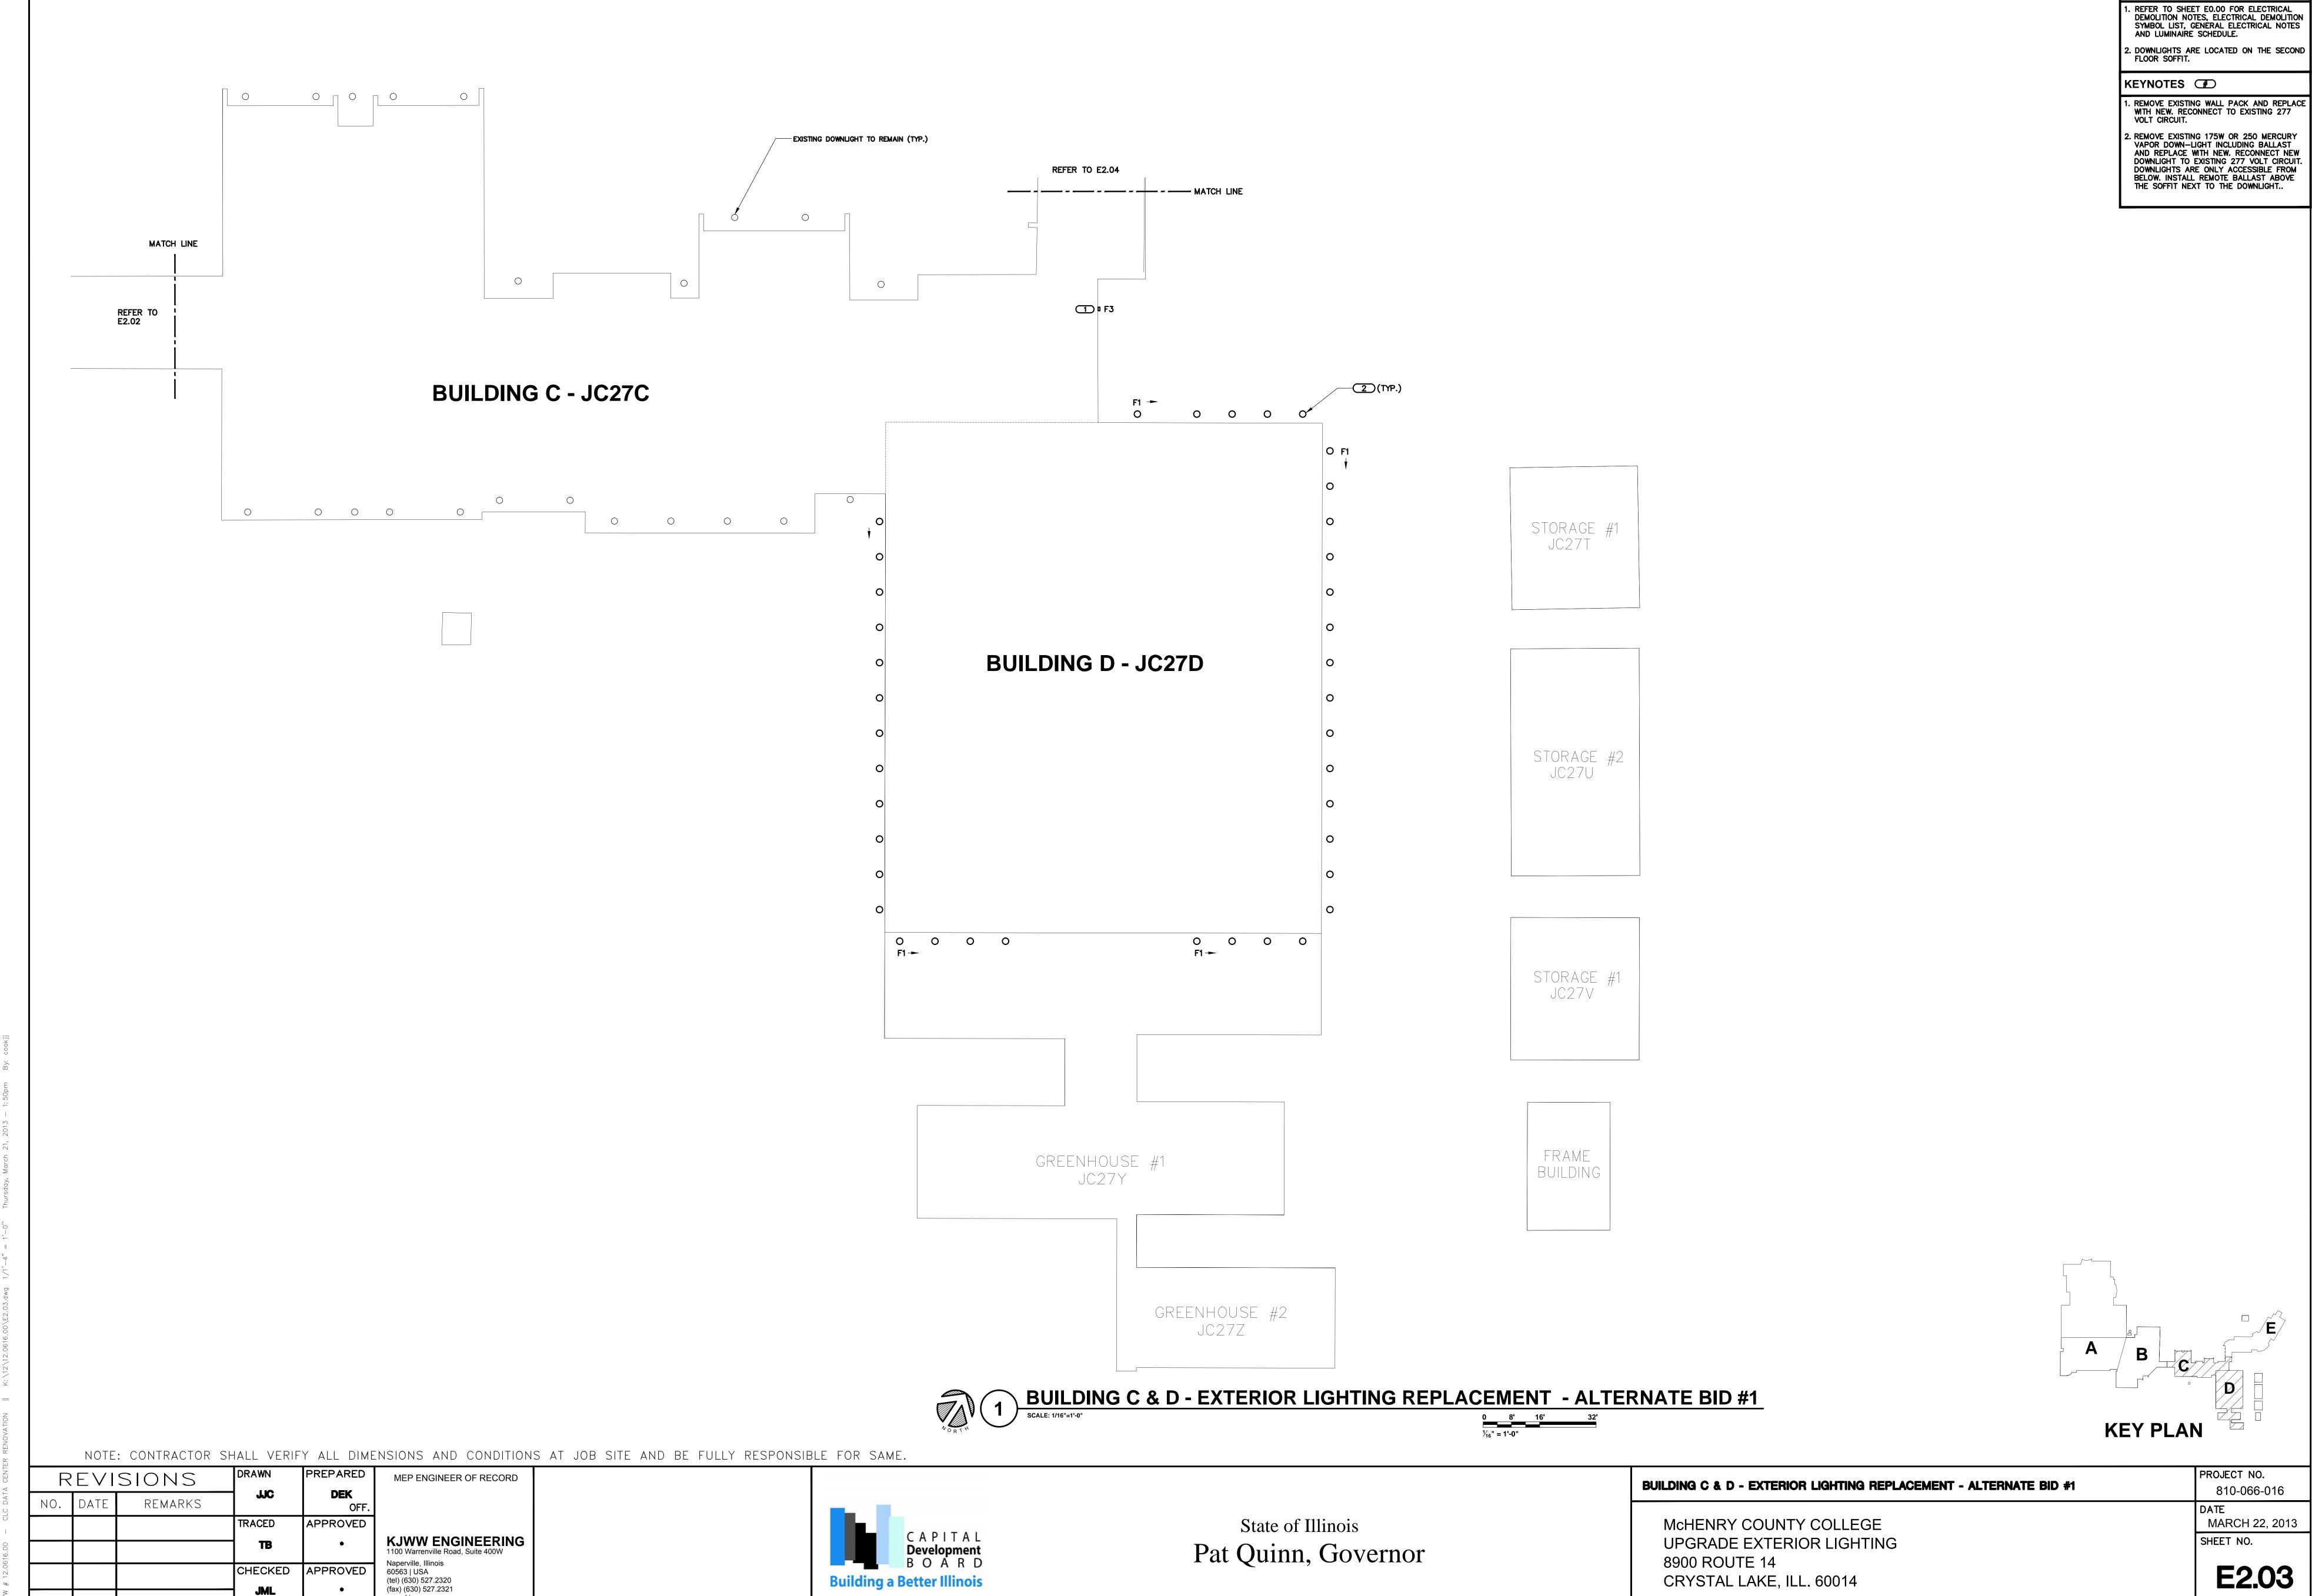
KJWW ENGINEERING
1100 Warrenville Road, Suite 400W

Naperville, Illinois 60563 | USA (tel) (630) 527.2320 (fax) (630) 527.2321 www.kjww.com

TRACED

CHECKED



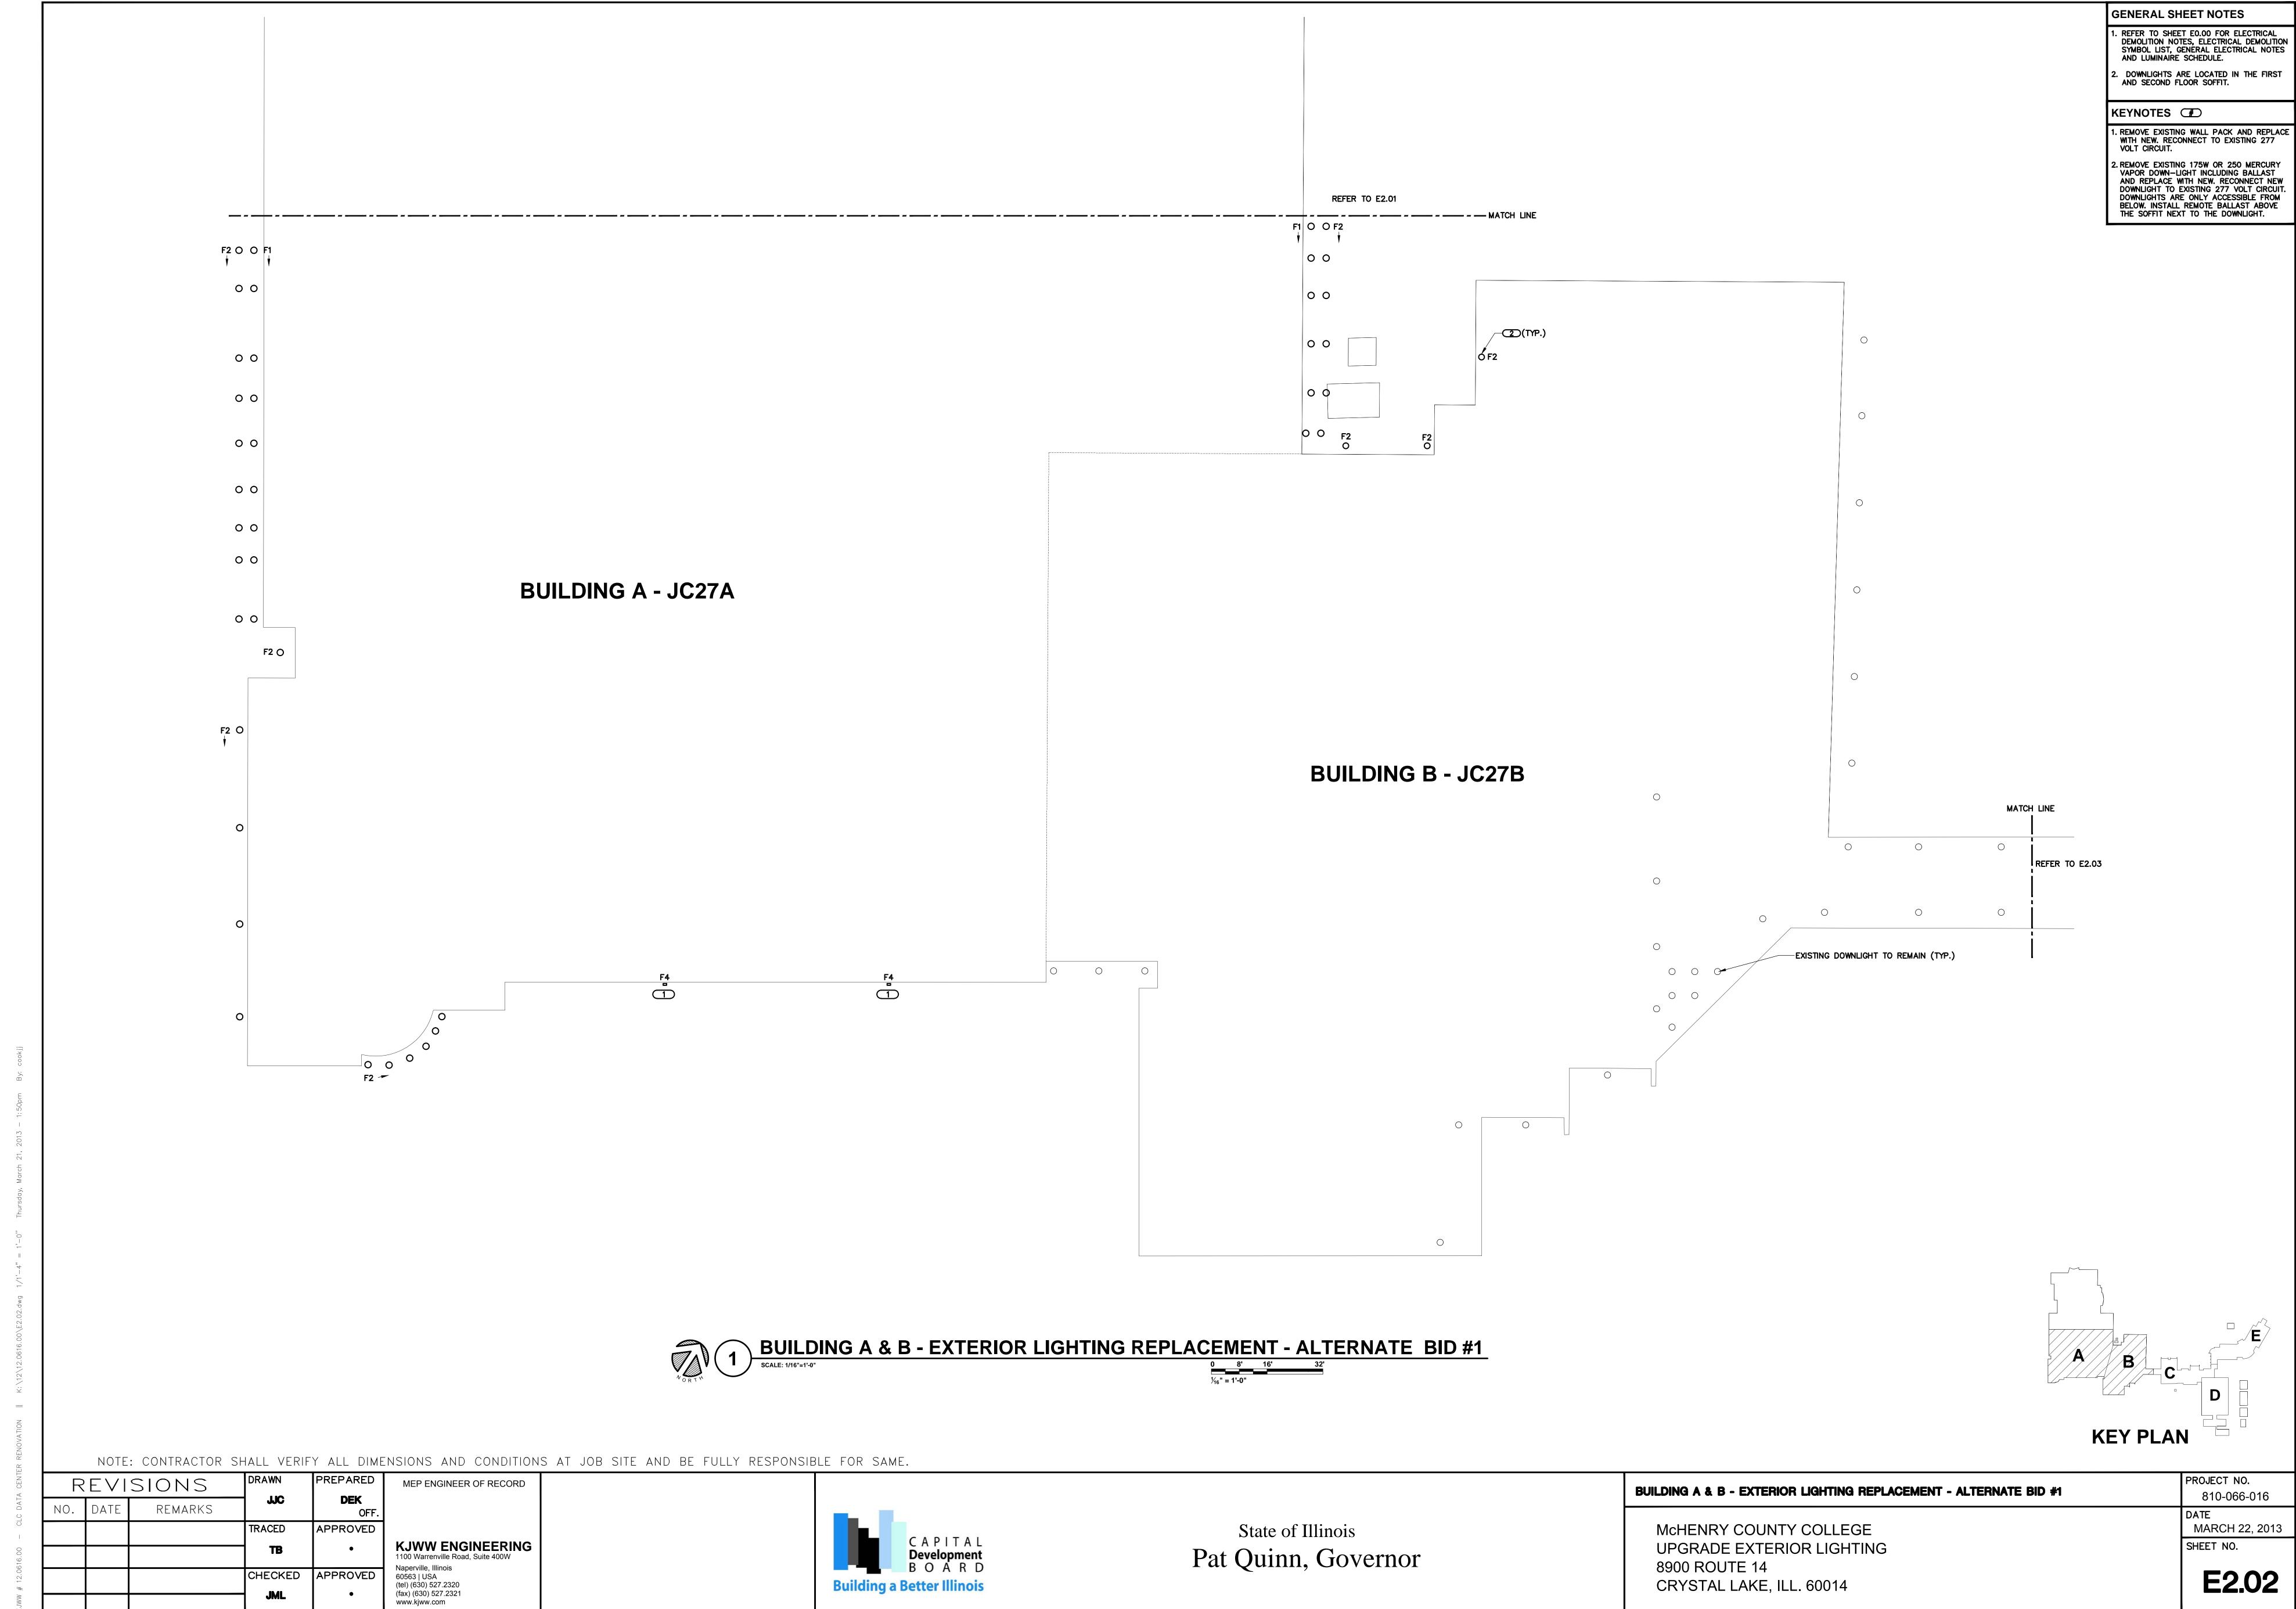


GENERAL SHEET NOTES

12 0616 00 - CLC DATA CENTER RENOVATION || K·\12\12 0616 00\F2 03 dwg 1/1'-4" = 1'-0" Thursday March 21 2013 - 1:50pm By

www.kjww.com

1. REMOVE EXISTING WALL PACK AND REPLACE WITH NEW. RECONNECT TO EXISTING 277 VOLT CIRCUIT.

KEYNOTES

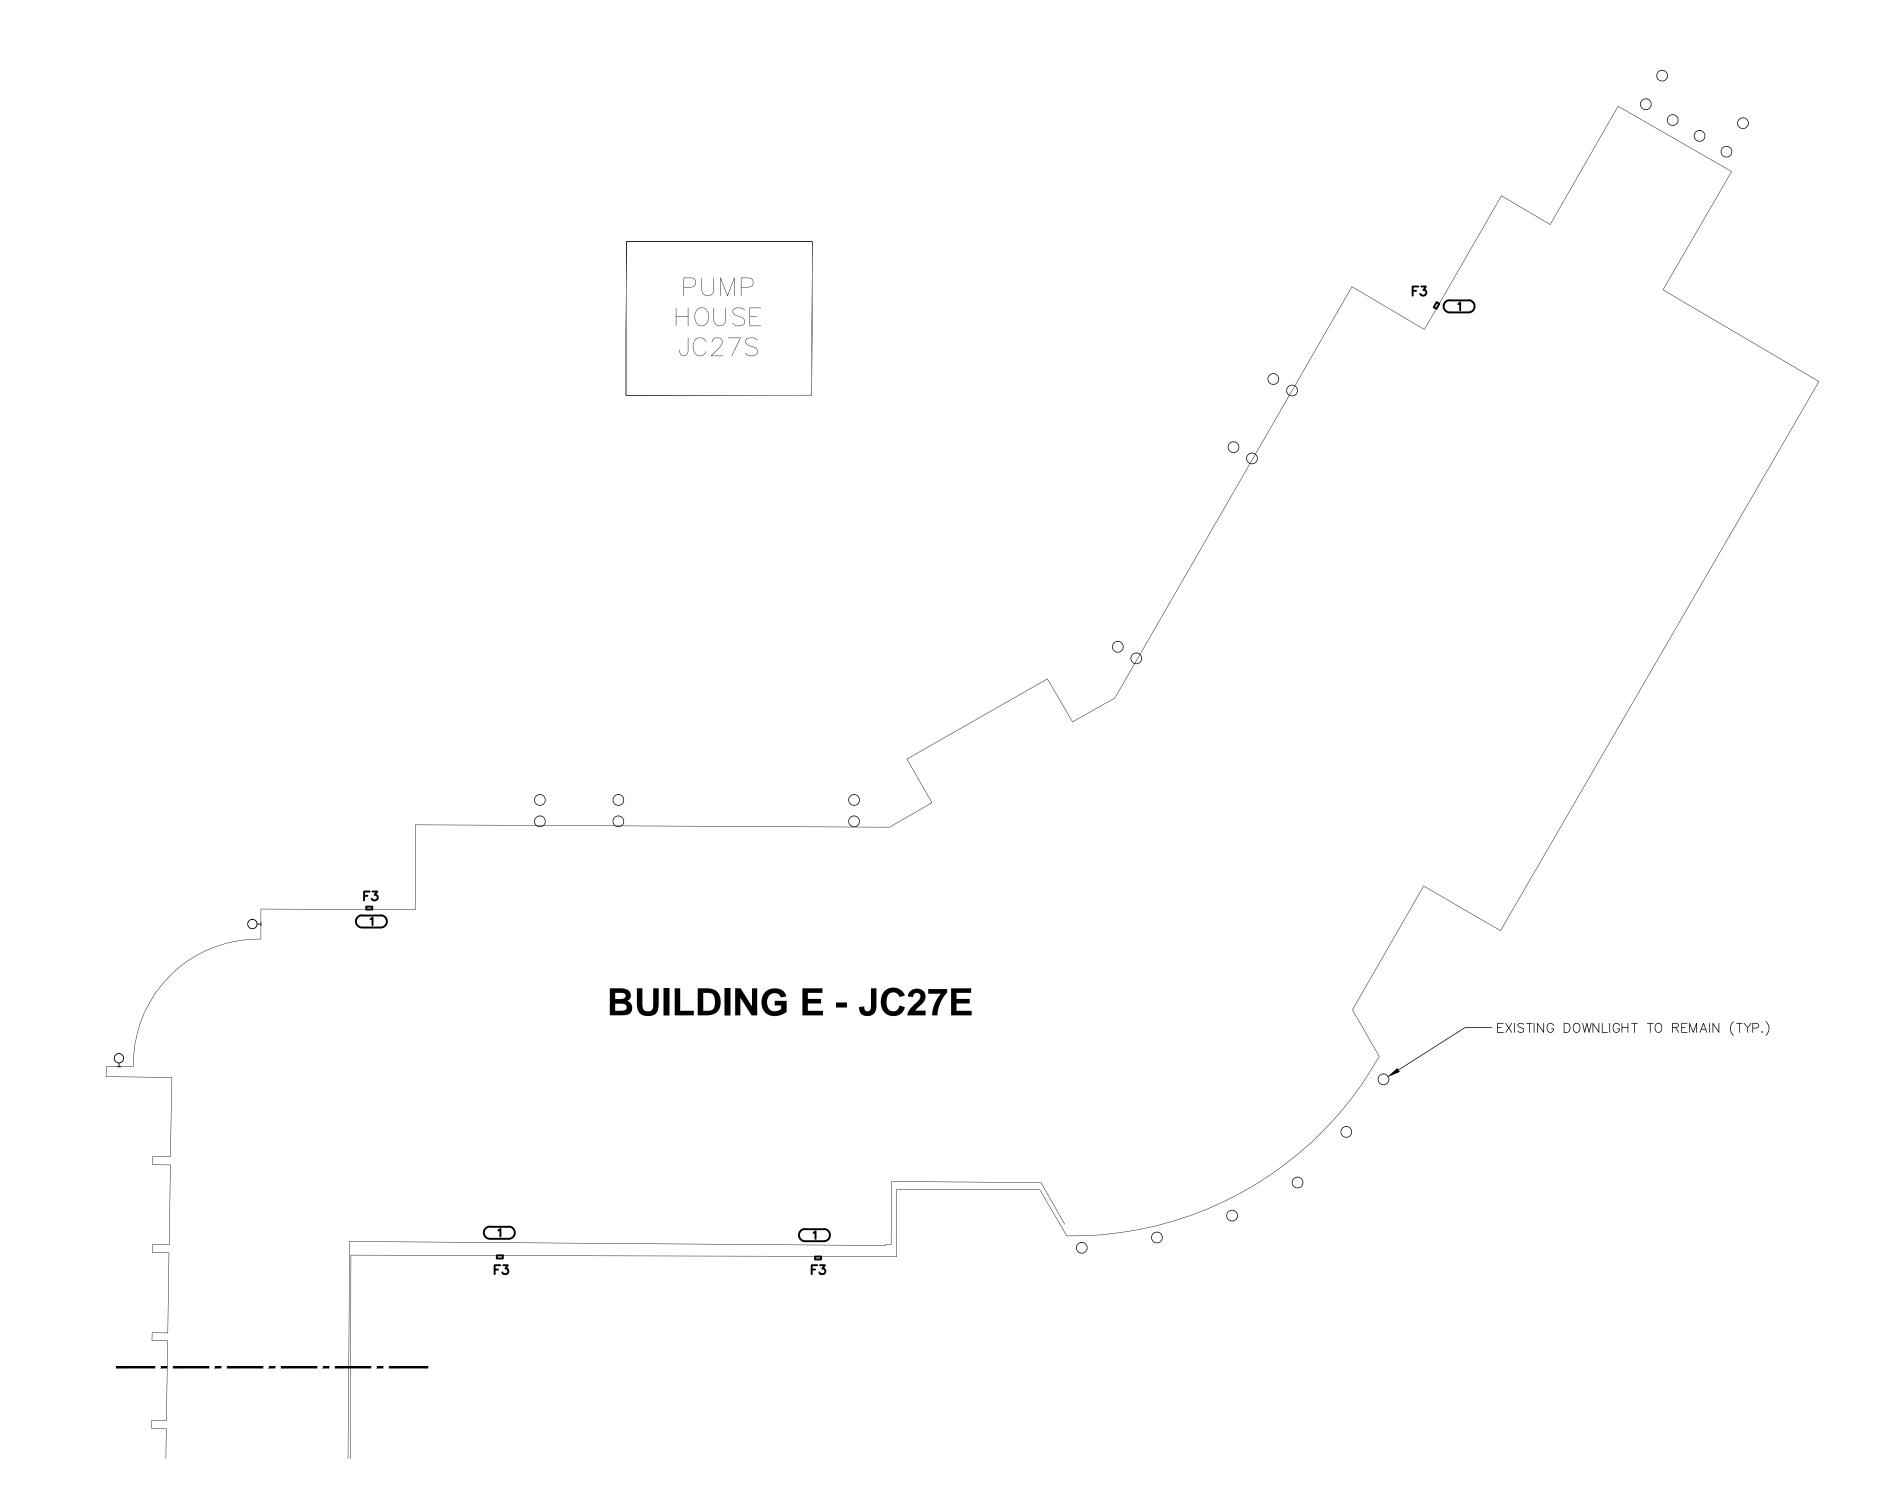

BUILDING E - EXTERIOR LIGHTING REPLACEMENT - ALTERNATE BID #1

SCALE: 1/16"=1'-0"

D 8' 16' 32'

1/16" = 1'-0"

A B C D C KEY PLAN

NOTE: CONTRACTOR SHALL VERIFY ALL DIMENSIONS AND CONDITIONS AT JOB SITE AND BE FULLY RESPONSIBLE FOR SAME.

	NOIE	: CUNTRACTOR 3	MALL VERIF	I ALL DIME	-11/2
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MEP ENGINEER OF RECORD

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Naperville, Illinois
60563 | USA
(tel) (630) 527.2320
(fax) (630) 527.2321
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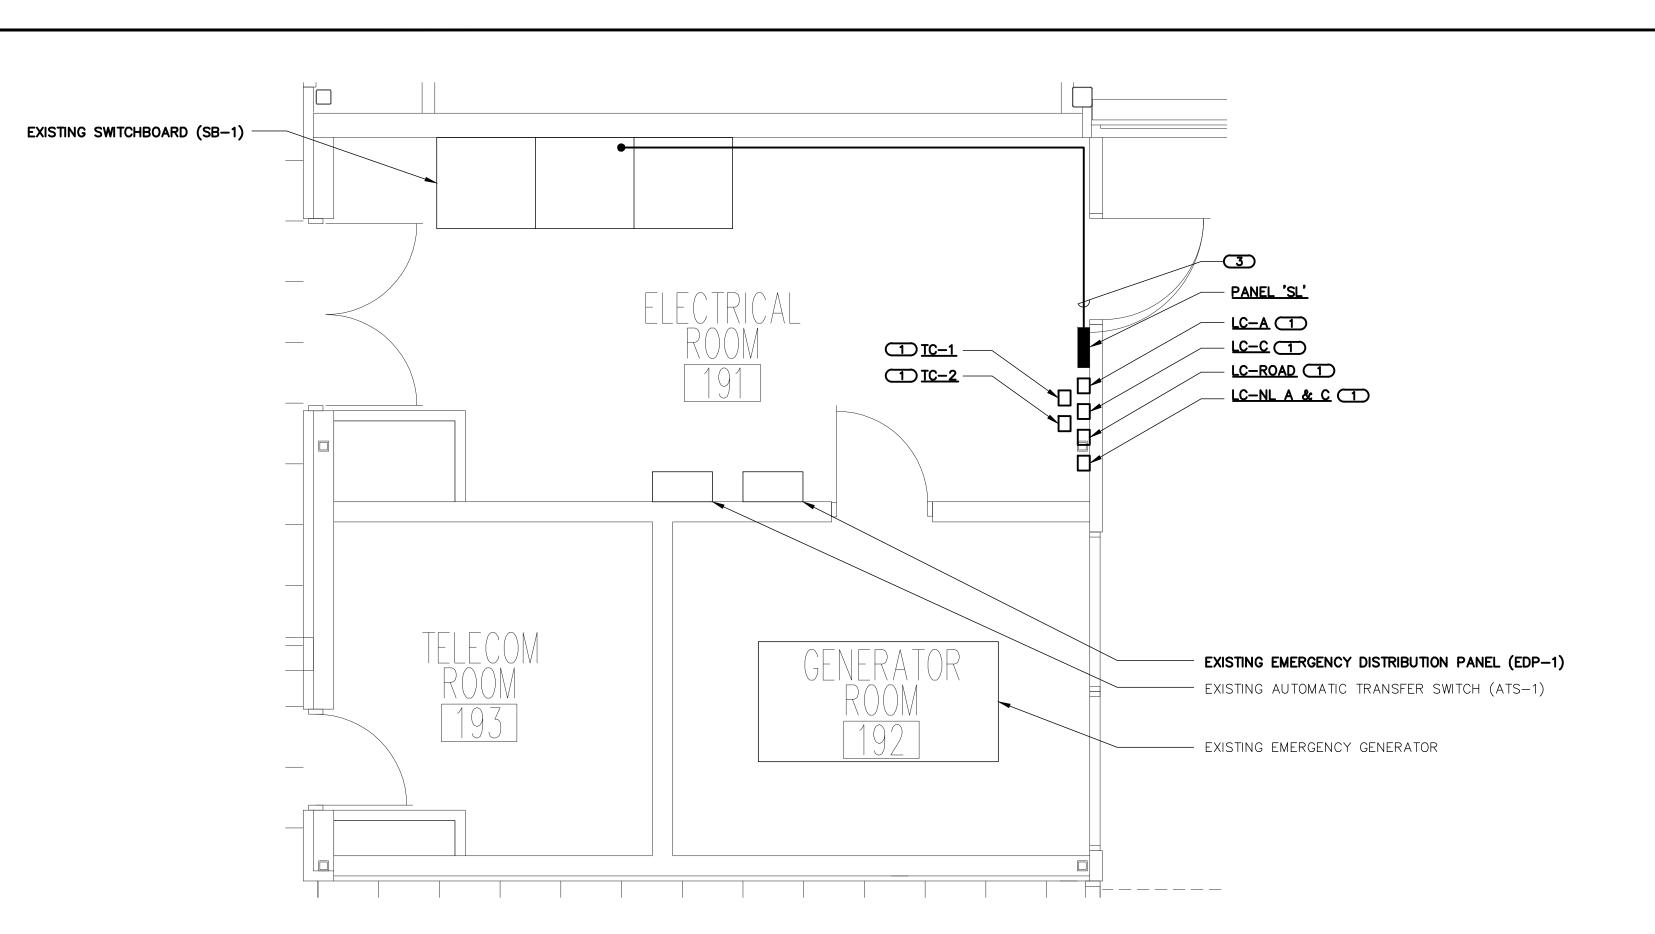


State of Illinois
Pat Quinn, Governor


BUILDING E - EXTERIOR LIGHTING REPLACEMENT - ALTERNATE BID #1

McHENRY COUNTY COLLEGE UPGRADE EXTERIOR LIGHTING 8900 ROUTE 14 CRYSTAL LAKE, ILL. 60014

PROJECT NO.
810-066-016
DATE
MARCH 22, 2013




# BUILDING A - ENLARGED ELECTRICAL ROOM 191 SCALE: 1/4"=1'-0"

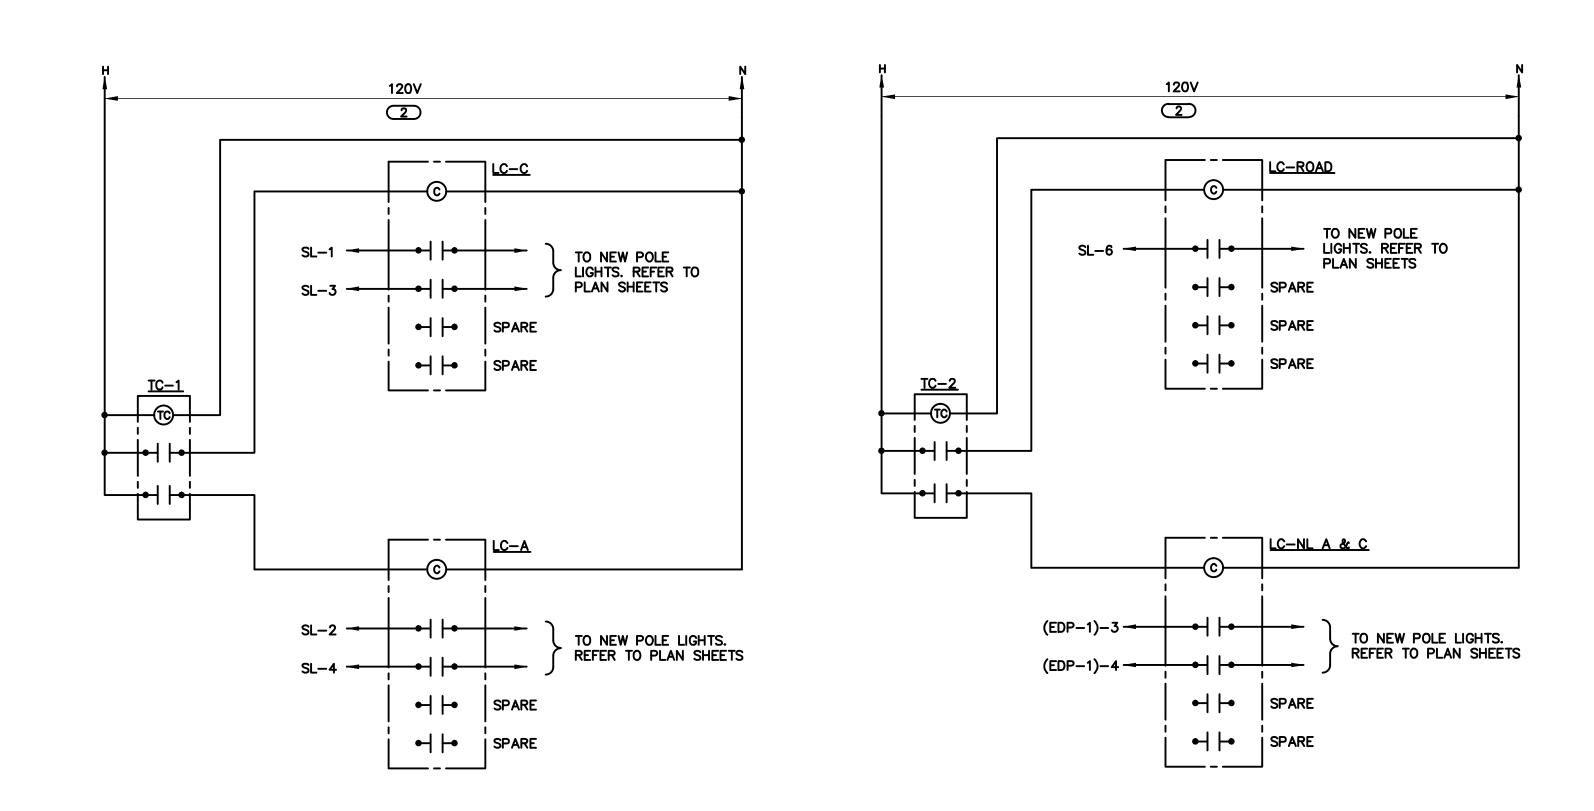

EXTERIOR LIGHTING CONTROL WIRING - ROOM 191


NOTES:
1. POST AS-CONSTRUCTED WIRING DIAGRAM AT CONTACTORS.

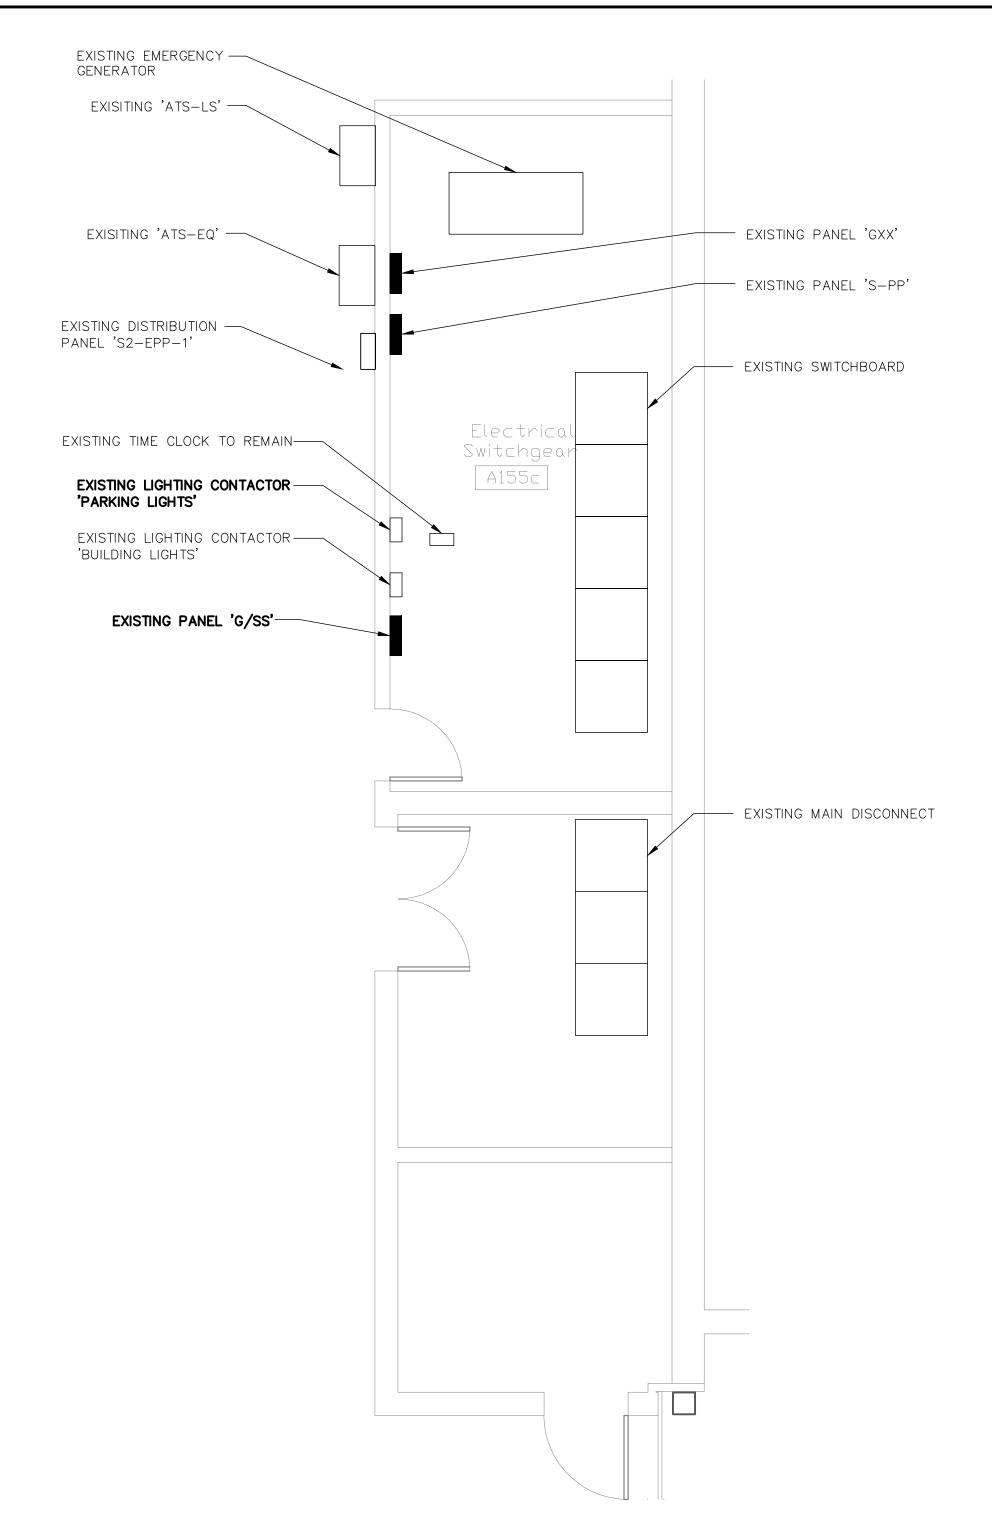

BUILDING A - ENLARGED ELECTRICAL ROOM A155C

SCALE: 1/4"=1'-0"

CRYSTAL LAKE, ILL. 60014

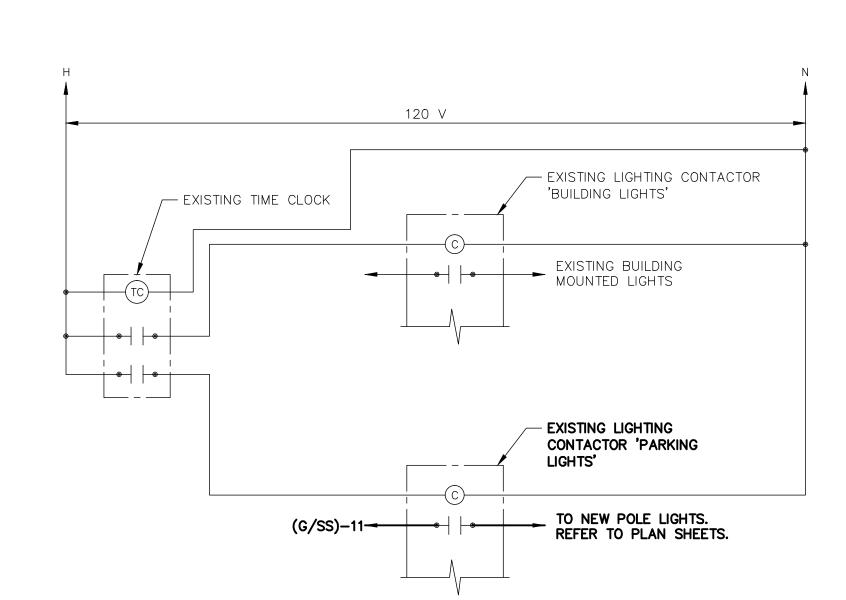

3 EXTERIOR LIGHTING CONTROL WIRING - ROOM A155C

NOTE: CONTRACTOR SHALL VERIFY ALL DIMENSIONS AND CONDITIONS AT JOB SITE AND BE FULLY RESPONSIBLE FOR SAME.

REVISIONS

NO. DATE REMARKS

DRAWN

DEK

OFF.

TRACED APPROVED

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CHECKED APPROVED

JML

ORAWN

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OFF.

KJWW ENGINEER OF RECORD

KJWW ENGINEERING

1100 Warrenville Road, Suite 400W

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Pat Quinn, Governor

ENLARGED ELECTRICAL ROOMS & WIRING DETAILS

MCHENRY COUNTY COLLEGE

UPGRADE EXTERIOR LIGHTING

8900 ROUTE 14

PROJECT NO.

810-066-016

MARCH 22, 2013

SHEET NO.

**E2.05** 

GENERAL SHEET NOTES

KEYNOTES #

DIAGRAM 1/E4.00.

1. REFER TO SHEET E0.00 FOR GENERAL ELECTRICAL NOTES, ELECTRICAL INSTALLATION NOTES, GENERAL ELECTRICAL EQUIPMENT SCHEDULE.


REFER TO WIRING DETAIL 4/E2.05.


EXTEND EXISTING 120V RECEPTACLE CIRCUIT PA-68 SERVING ROOM 191.

PANEL FEEDER. REFER TO ONE LINE

2'-0" DIA.



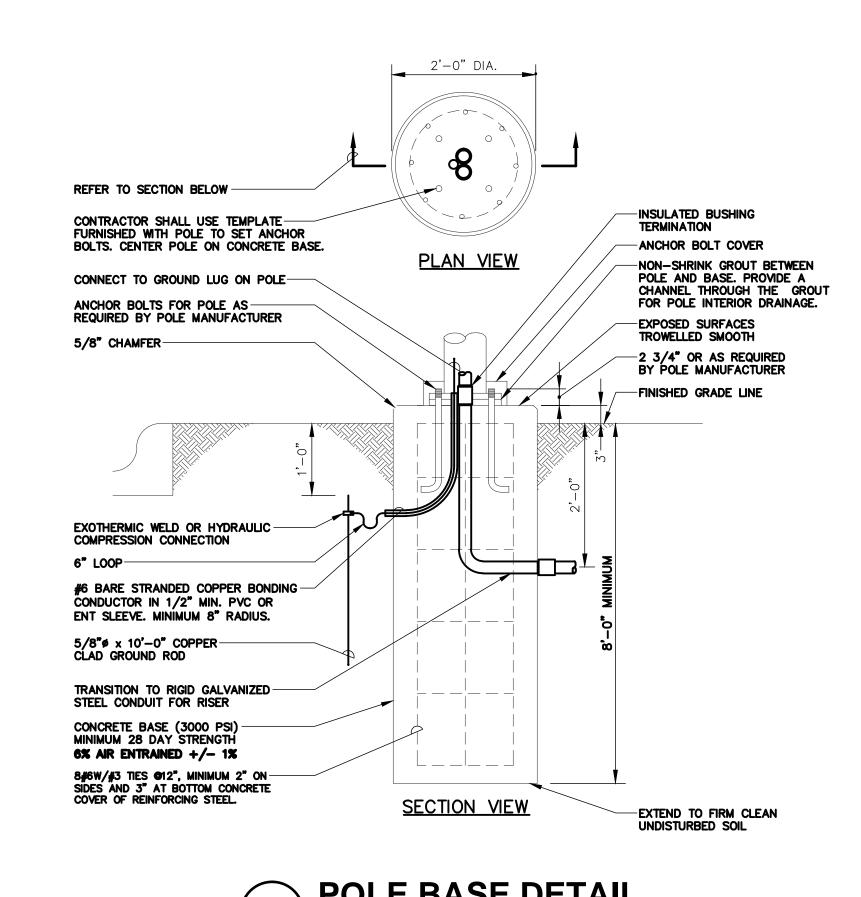

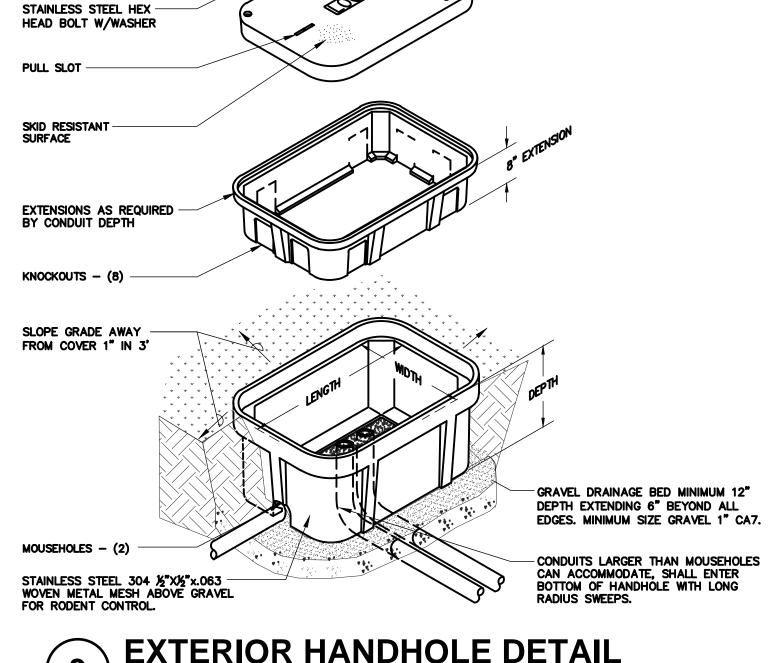

EXTERIOR HANDHOLE DETAIL

2. ALL SPLICES OR DEVICES IN HANDHOLE SHALL BE UL LISTED FOR SUBMERSIBLE APPLICATIONS.

NOTE: CONTRACTOR SHALL VERIFY ALL DIMENSIONS AND CONDITIONS AT JOB SITE AND BE FULLY RESPONSIBLE FOR SAME.

	NOTE	: CONTRACTOR SI	HALL VERIF	Y ALL DIME	NSIONS AND CONDITIONS
R	EVI	SIONS	DRAWN	PREPARED	MEP ENGINEER OF RECORD
NO.	DATE	REMARKS	- nc	<b>DEK</b> OFF.	
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			ТВ	•	KJWW ENGINEERING 1100 Warrenville Road, Suite 400W
			CHECKED	APPROVED	Naperville, Illinois 60563   USA (tel) (630) 527.2320
			JML	•	(fax) (630) 527.2321 www.kjww.com



TO UTILITY SERVICE ENTRANCE EXISITING SWITCHBOARD ('SB-1') (SQUARE D) ONE LINE DIAGRAM NOTES: 1 SCCR AND AIC RATINGS LISTED FOR EQUIPMENT ARE MINIMUM REQUIREMENTS FOR BUS BRACING AND DEVICE RATING. ALL TYPE: BOLT-ON 480/277V, 3ø, 4W MOUNTING: SURFACE EQUIPMENT SHALL BE FULLY RATED UNLESS SPECIFICALLY NOTED 65,000 AIC FED FROM: EXISTING SWITCHBOARD (SB-1) AS "SERIES RATED". K SCCR: 18,000 INDICATES DIRECT CONNECTION OF GROUND CONDUCTOR NOTES: TO GROUND BUS. INDICATES O.Z. GEDNEY OR EQUAL GROUND BUSHING BONDED TO GROUND BUS WITH CONDUCTOR SIZED TO NO. LOAD DESCRIPTION SITE LIGHTING LOT C MAXIMUM FEEDER GROUND CAPACITY. 3 SITE LIGHTING LOT C 4 ALL WIRE SHALL BE TYPE "THHN" ABOVE GRADE. FEEDERS LOCATED BELOW FLOOR SLAB OR UNDERGROUND SHALL BE TYPE 5 SPARE 7 SPARE 9 SPARE
11 SPACE
13 SPACE 15 SPACE
17 SPACE
19 SPACE
21 SPACE 1600A/3P \_ C.T.'S 23 SPACE 25 SPACE
27 SPACE
29 SPACE
KEY: \*C=THRU CONTACTOR P.T.'S 60A/3P → TO EXISTING PANEL 'TVSS-1' 100A/3P ─ TO EXISTING PANEL 'LA' 100A/3P → TO EXISTING PANEL 'LB' 100A/3P → TO EXISTING PANEL 'LC' → TO EXISTING PANEL 'DP-1' -EXISTING EMERGENCY → TO EXISTING SWITCHBOARD 'SB-2' EXISTING AUTOMATIC TRANSFER SWITCH — (ATS-1)NEW PANEL 'SL' 5.7 KVA 480/277V, 3ø, 4W 35,000 AIC EXISTING EMERERGENCY
DISTRIBUTION PANEL (SQUARE D) → TO EXISTING PANEL 'EE' → TO EXISTING PANEL 'EE' VIA TR-30 /-3#8 & 1#8 GND. IN 2" C. → TO NEW POLE LIGHTS VIA LC-NL A & C. REFER TO PLAN SHEET E1.01

GENERAL SHEET NOTES 1. REFER TO SHEET E0.00 FOR GENERAL ELECTRICAL NOTES, ELECTRICAL
INSTALLATION NOTES, GENERAL ELECTRICAL
EQUIPMENT SCHEDULE AND LUMINAIRE
SCHEDULE.

KEYNOTES

CONNECTED 5.7 KVA

24

100A LUGS

480Y / 277

LOAD DESCRIPTION

SPARE

SPARE SPACE SPACE

SPACE SPACE SPACE SPACE

SPACE

SPACE SPACE

SITE LIGHTING LOT A

VOLTS:

PHASE:

 8
 1.3
 - - - 1.1
 8
 SITE LIGHTING LOT A

 20
 1
 - - 0.6
 8
 SITE LIGHTING RING ROAD

 20
 1
 20
 1
 SPARE

SPACE

PANEL NAME: SL

SOLID NEUTRAL

GROUND BUS

| WIRE | LOAD | BREAKER | BREAKER | LOAD | WIRE |

SIZE KVA AMP P AMP P KVA SIZE

. INSTALL NEW CIRCUIT BREAKER IN EXISTING SPACE. MATCH EXISTING CIRCUIT BREAKER TYPE AND AIC RATING. PROVIDE ALL REQUIRED MOUNTING ACCESSORIES.

NOTE: CONTRACTOR SHALL VERIFY ALL DIMENSIONS AND CONDITIONS AT JOB SITE AND BE FULLY RESPONSIBLE FOR SAME.

1 PARTIAL ONE - LINE DIAGRAM
NO SCALE

Y Y		NOIE	: CONTRACTOR S	HALL VERIF	Y ALL DIME	<u>.</u> N
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MEP ENGINEER OF RECORD KJWW ENGINEERING
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GROUND

State of Illinois Pat Quinn, Governor PARTIAL ONE - LINE DIAGRAM McHENRY COUNTY COLLEGE UPGRADE EXTERIOR LIGHTING 8900 ROUTE 14

CRYSTAL LAKE, ILL. 60014

PROJECT NO.

SHEET NO.

810-066-016

MARCH 22, 2013